

A. AS APPLICABLE THIS CONTRACTOR SHALL VERIFY AND COORDINATE PLUMBING EQUIPMENT

TO BE TURNED OVER TO OWNER. B. THIS CONTRACTOR SHALL VERIFY ALL AREAS SERVED BY PLUMBING SYSTEMS BEING

VA HOSPITAL. WORK MAY HAVE TO BE PERFORMED DURING NON-WORKING HOURS. C. THIS CONTRACTOR WHERE REQUIRED SHALL PROVIDE A TEMPORARY MEANS FOR KEEPING EXISTING PLUMBING SYSTEMS IN SERVICE WHILE DEMOLITION AND NEW WORK IS BEING

D. CONTRACTOR SHALL FIELD VERIFY ALL PLUMBING ITEMS PRIOR TO COMMENCING NEW WORK. NO ADDITIONAL COSTS WILL BE ALLOWED FOR CONTRACTOR'S FAILURE TO BECOME FAMILIAR WITH ALL PLUMBING CONDITIONS.


SHEET KEYNOTES


REMOVE EXISTING VENT PIPING SHOWN BOLD AND DASHED ALONG WITH ASSOCIATED PIPE

- 2. EXISTING 5" STORM WATER PRIMARY DRAIN TO FIRST FLOOR TO REMAIN.
- . REMOVE EXISTING VENT BACK TO THIS POINT. SEE SHEET P2.5A FOR NEW WORK. COORDINATE VENT REMOVAL WITH EXISTING LABORATORY OPERATION.
- 4. EXISTING SANITARY PIPING SHOW LIGHT IS TO REMAIN.
- 5. REMOVE EXISTING VENT RISER. SEE SHEET P1.5 FOR CONTINUATION OF DEMOLITION WORK.
- 6. REMOVE EXISTING STORM WATER RISER AT ROOF TO 12" BELOW ROOF DECK. SEE P1.5 FOR
- REMOVE EXISTING STORM WATER OVERFLOW RISER AT ROOF BELOW ROOF DECK. SEE
- P1.5 FOR CONTINUATION OF DEMOLITION WORK. SEE SHEET P2.5A FOR NEW WORK.
- . REMOVE EXISTING STORM WATER OVERFLOW PIPING BACK TO THIS LOCATION. SEE SHEET P2.5A FOR NEW WORK.


P1 BUILDING 85 - SECOND FLOOR SANITARY DEMOLITION PLAN - AREA 'A' scale: 1/4" = 1'-0"

DATE

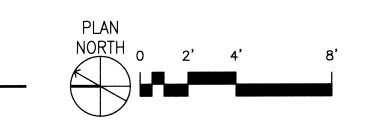

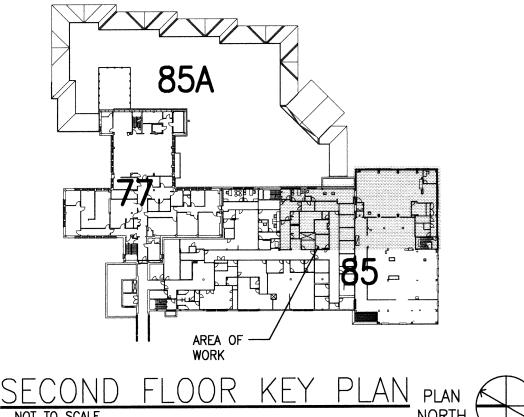



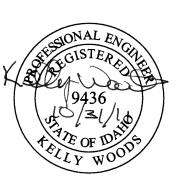




Architects and Planners, Chartered
565 W. Myrtle Street, Suite 225 Boise, Idaho 83702-7606 85A2FL 85P2WV 531-317_xVAbord


CAD FILE NAME: 531-317_P13A DEMOLITION PLAN AREA 'A'

REPLACE AND MODERNIZE 1
SURGERY / INTENSIVE SECOND FLOOR SANITARY SURGERY /

11/01/2011 531-317 APPROVED: CHIEF OF FACILITY MANAGEMENT SERVICE DRAWING NO. P1.3A APPROVED: MEDICAL CENTER DIRECTOR VAMC BOISE, IDAHO

FOR CONSTRUCTION DEPARTMENT OF VETERANS AFFAIRS

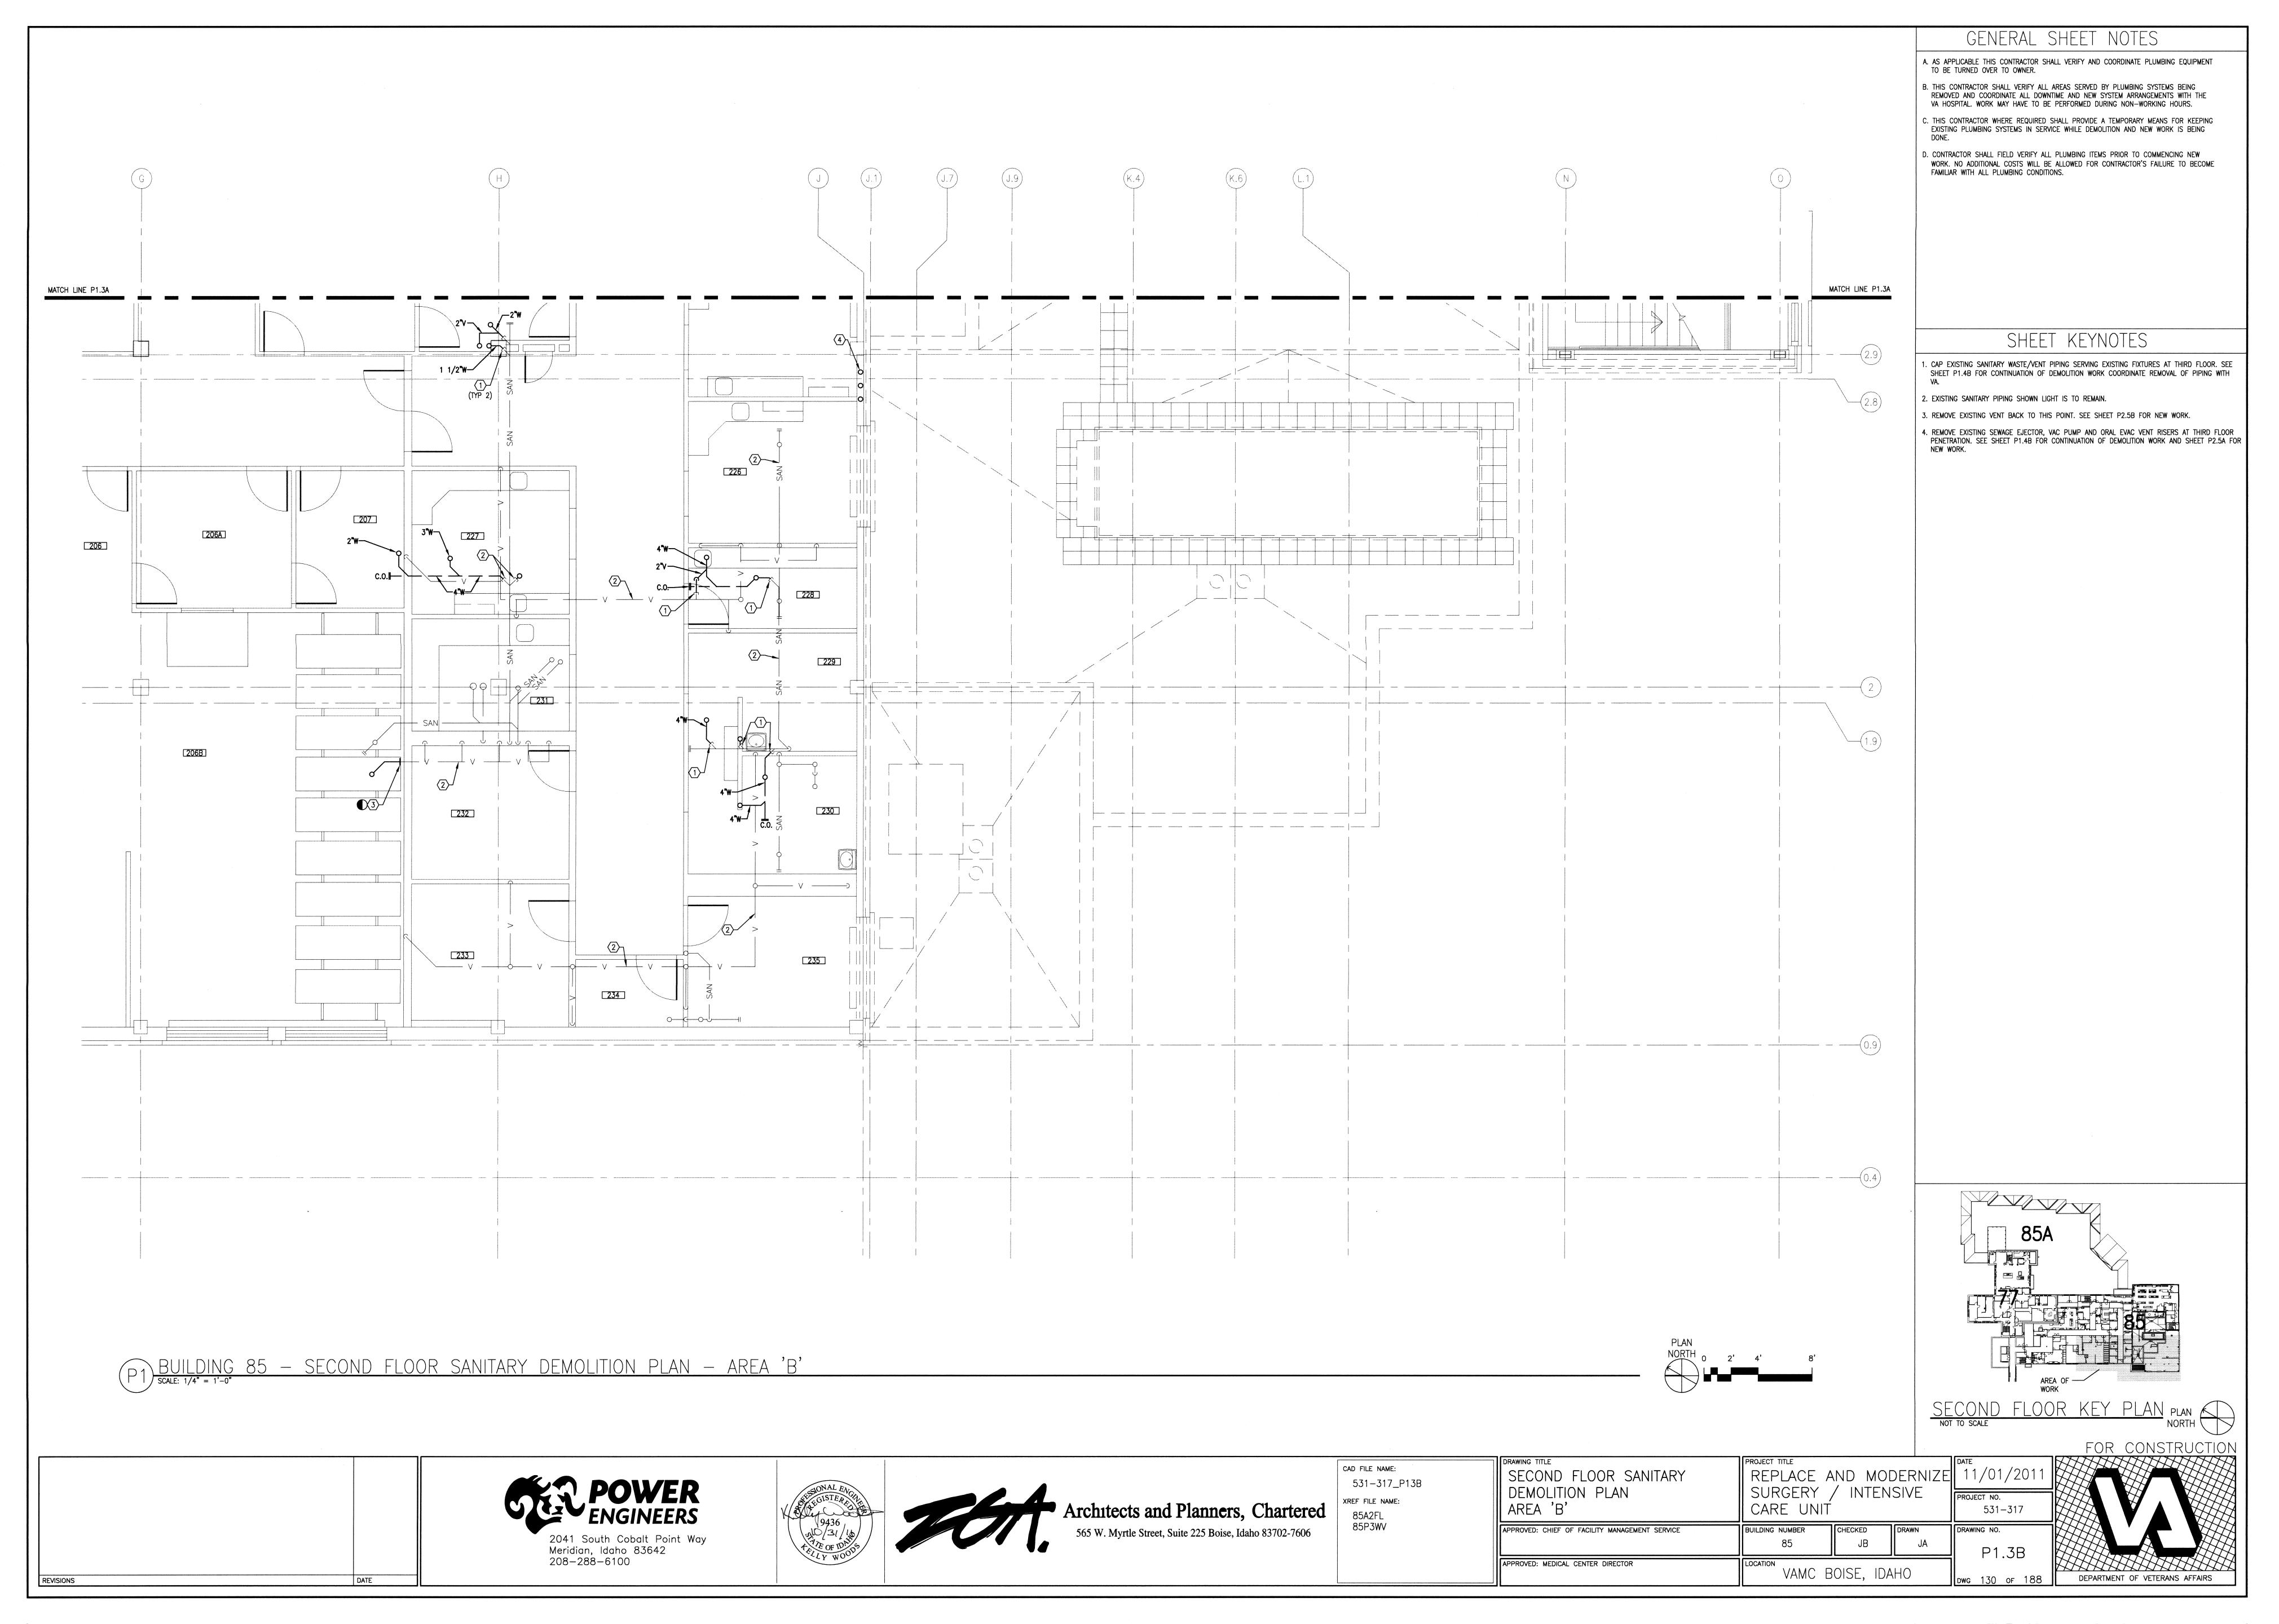

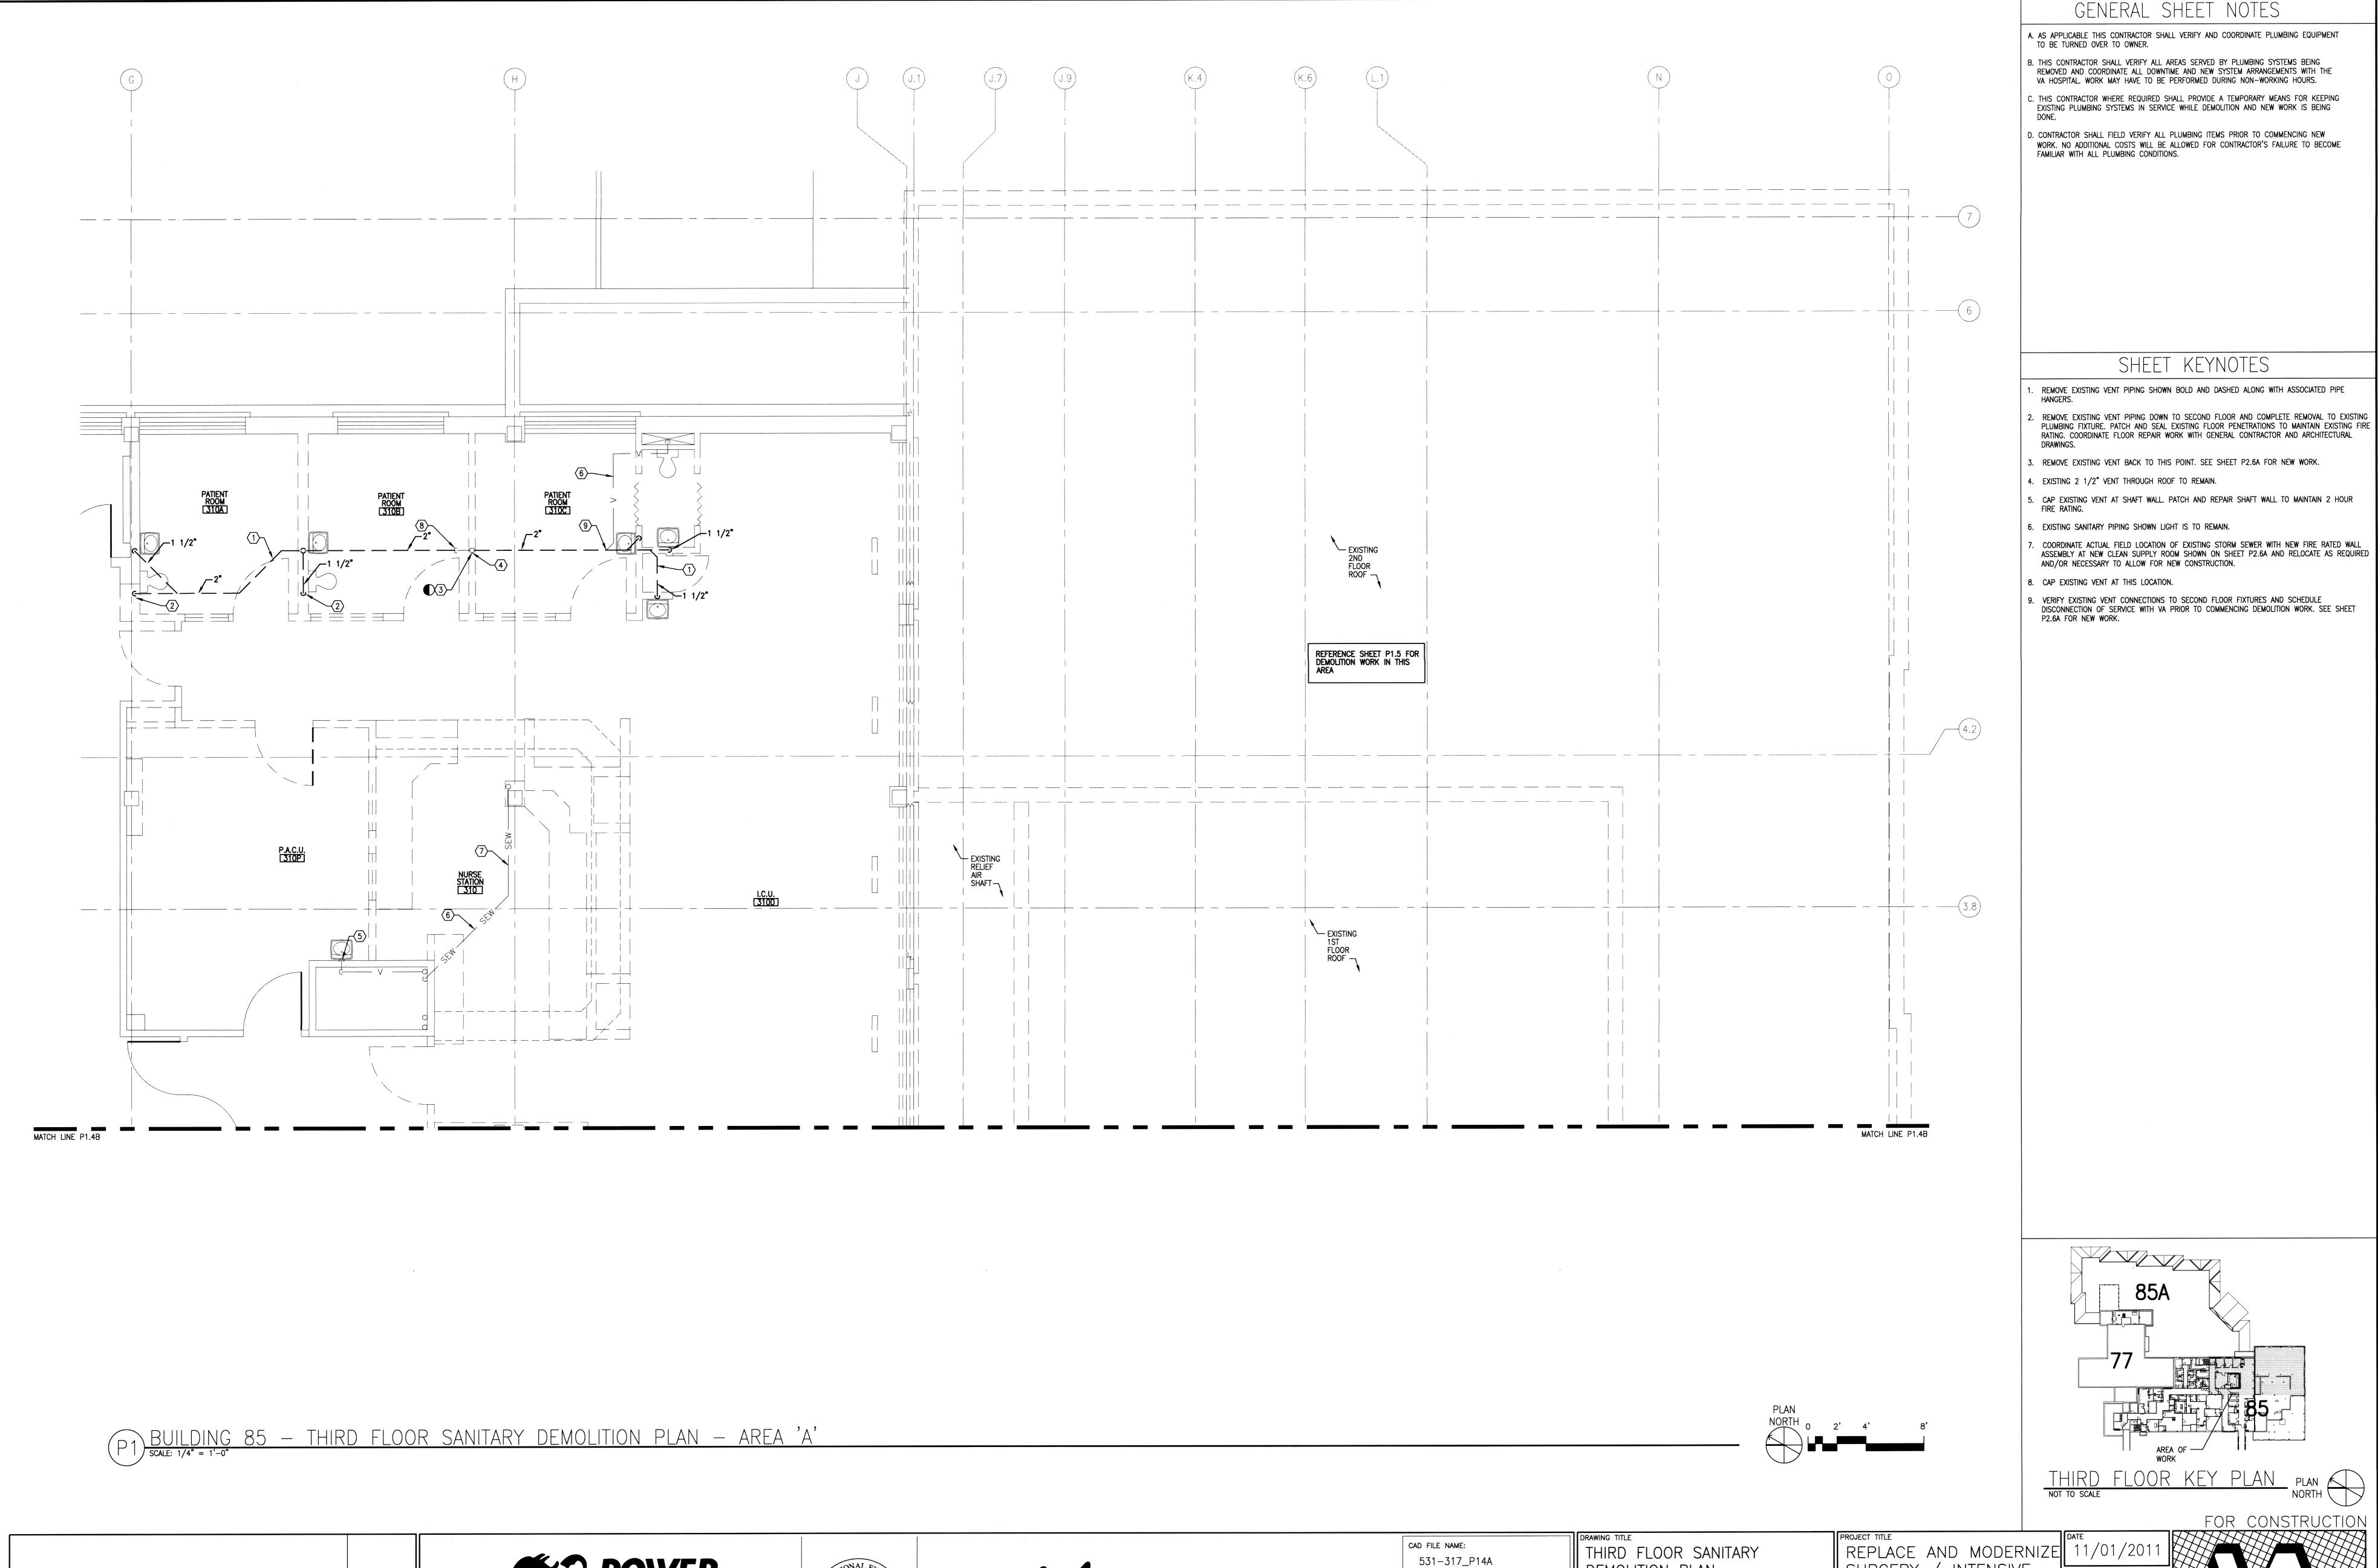

2041 South Cobalt Point Way Meridian, Idaho 83642 208—288—6100 Architects and Planners, Chartered

551-317_P14A

XREF FILE NAME:
85A3FL
85P3WV

Architects and Planners, Chartered
FOUND FILE NAME:
85A3FL
85P3WV

Architects and Planners, Chartered
FOUND FACILITY MANAGEMENT SERVICE

BUILDING NUMBER
85 PROVED: CHIEF OF FACILITY MANAGEMENT SERVICE


BUILDING NUMBER
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FOUND FACILITY MANAGEMENT SERVICE


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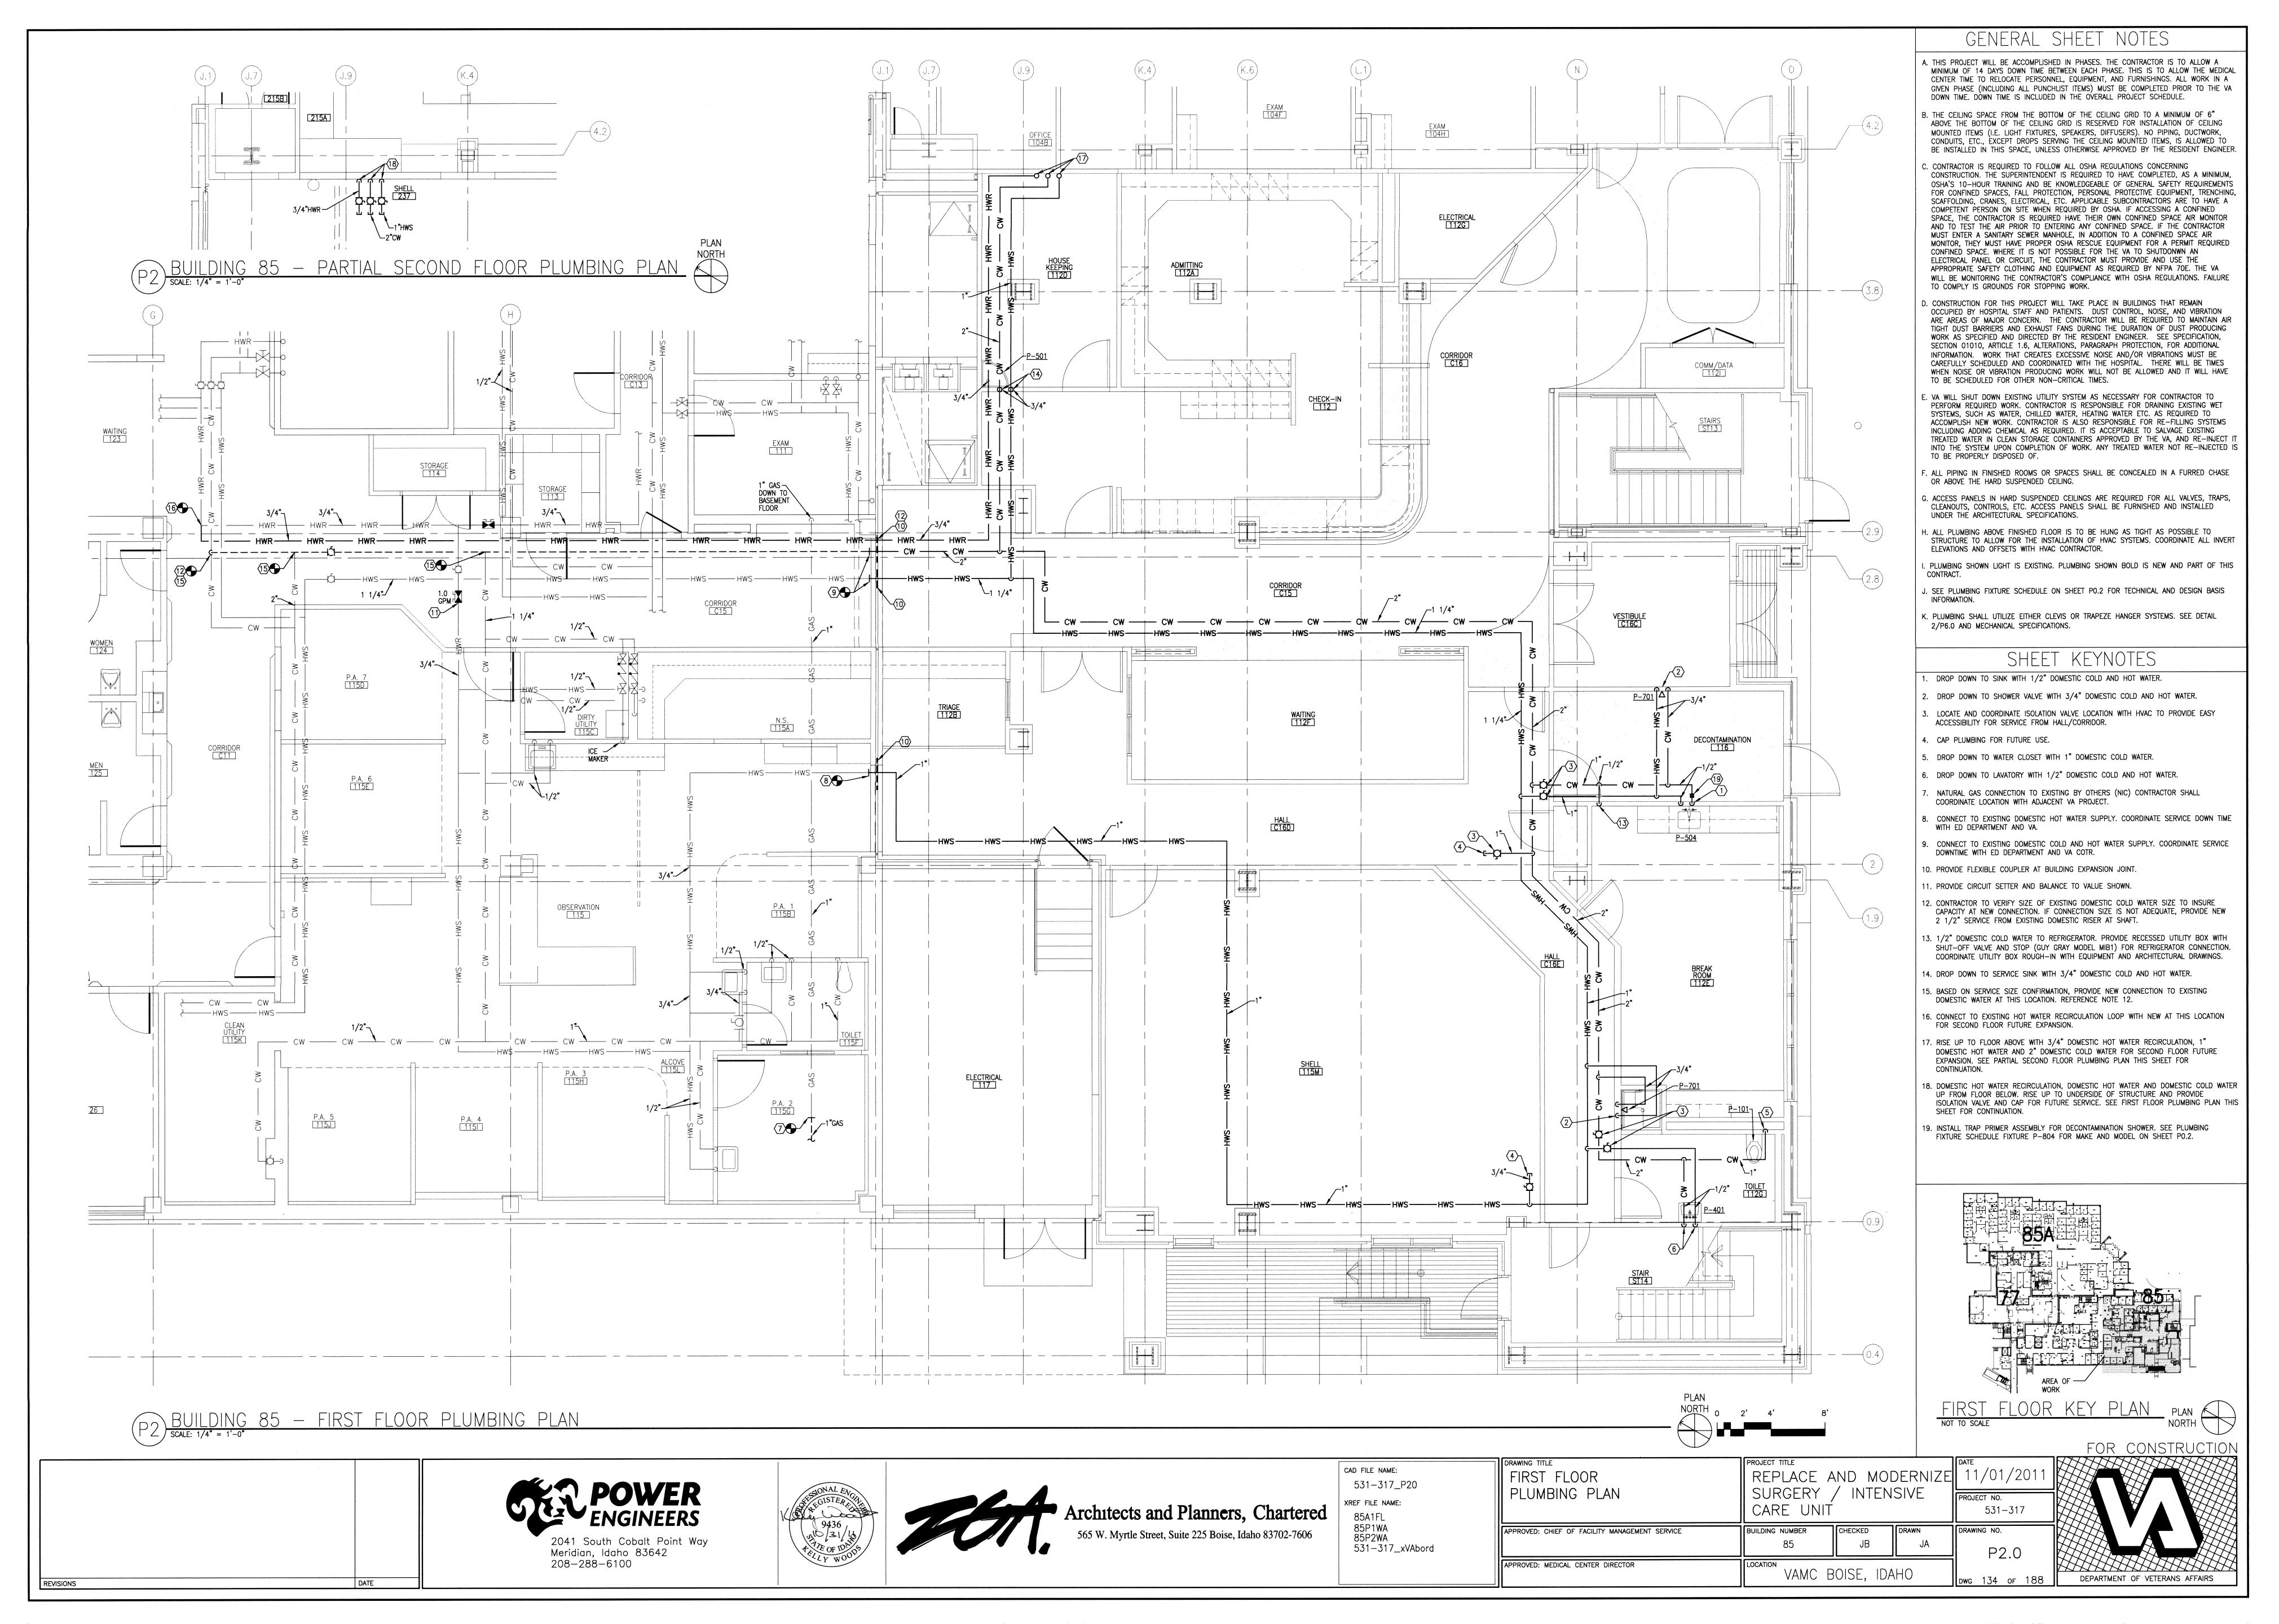
PP. 4A


PP. 4A

DEPARTMENT OF VETERANS AFFAIRS




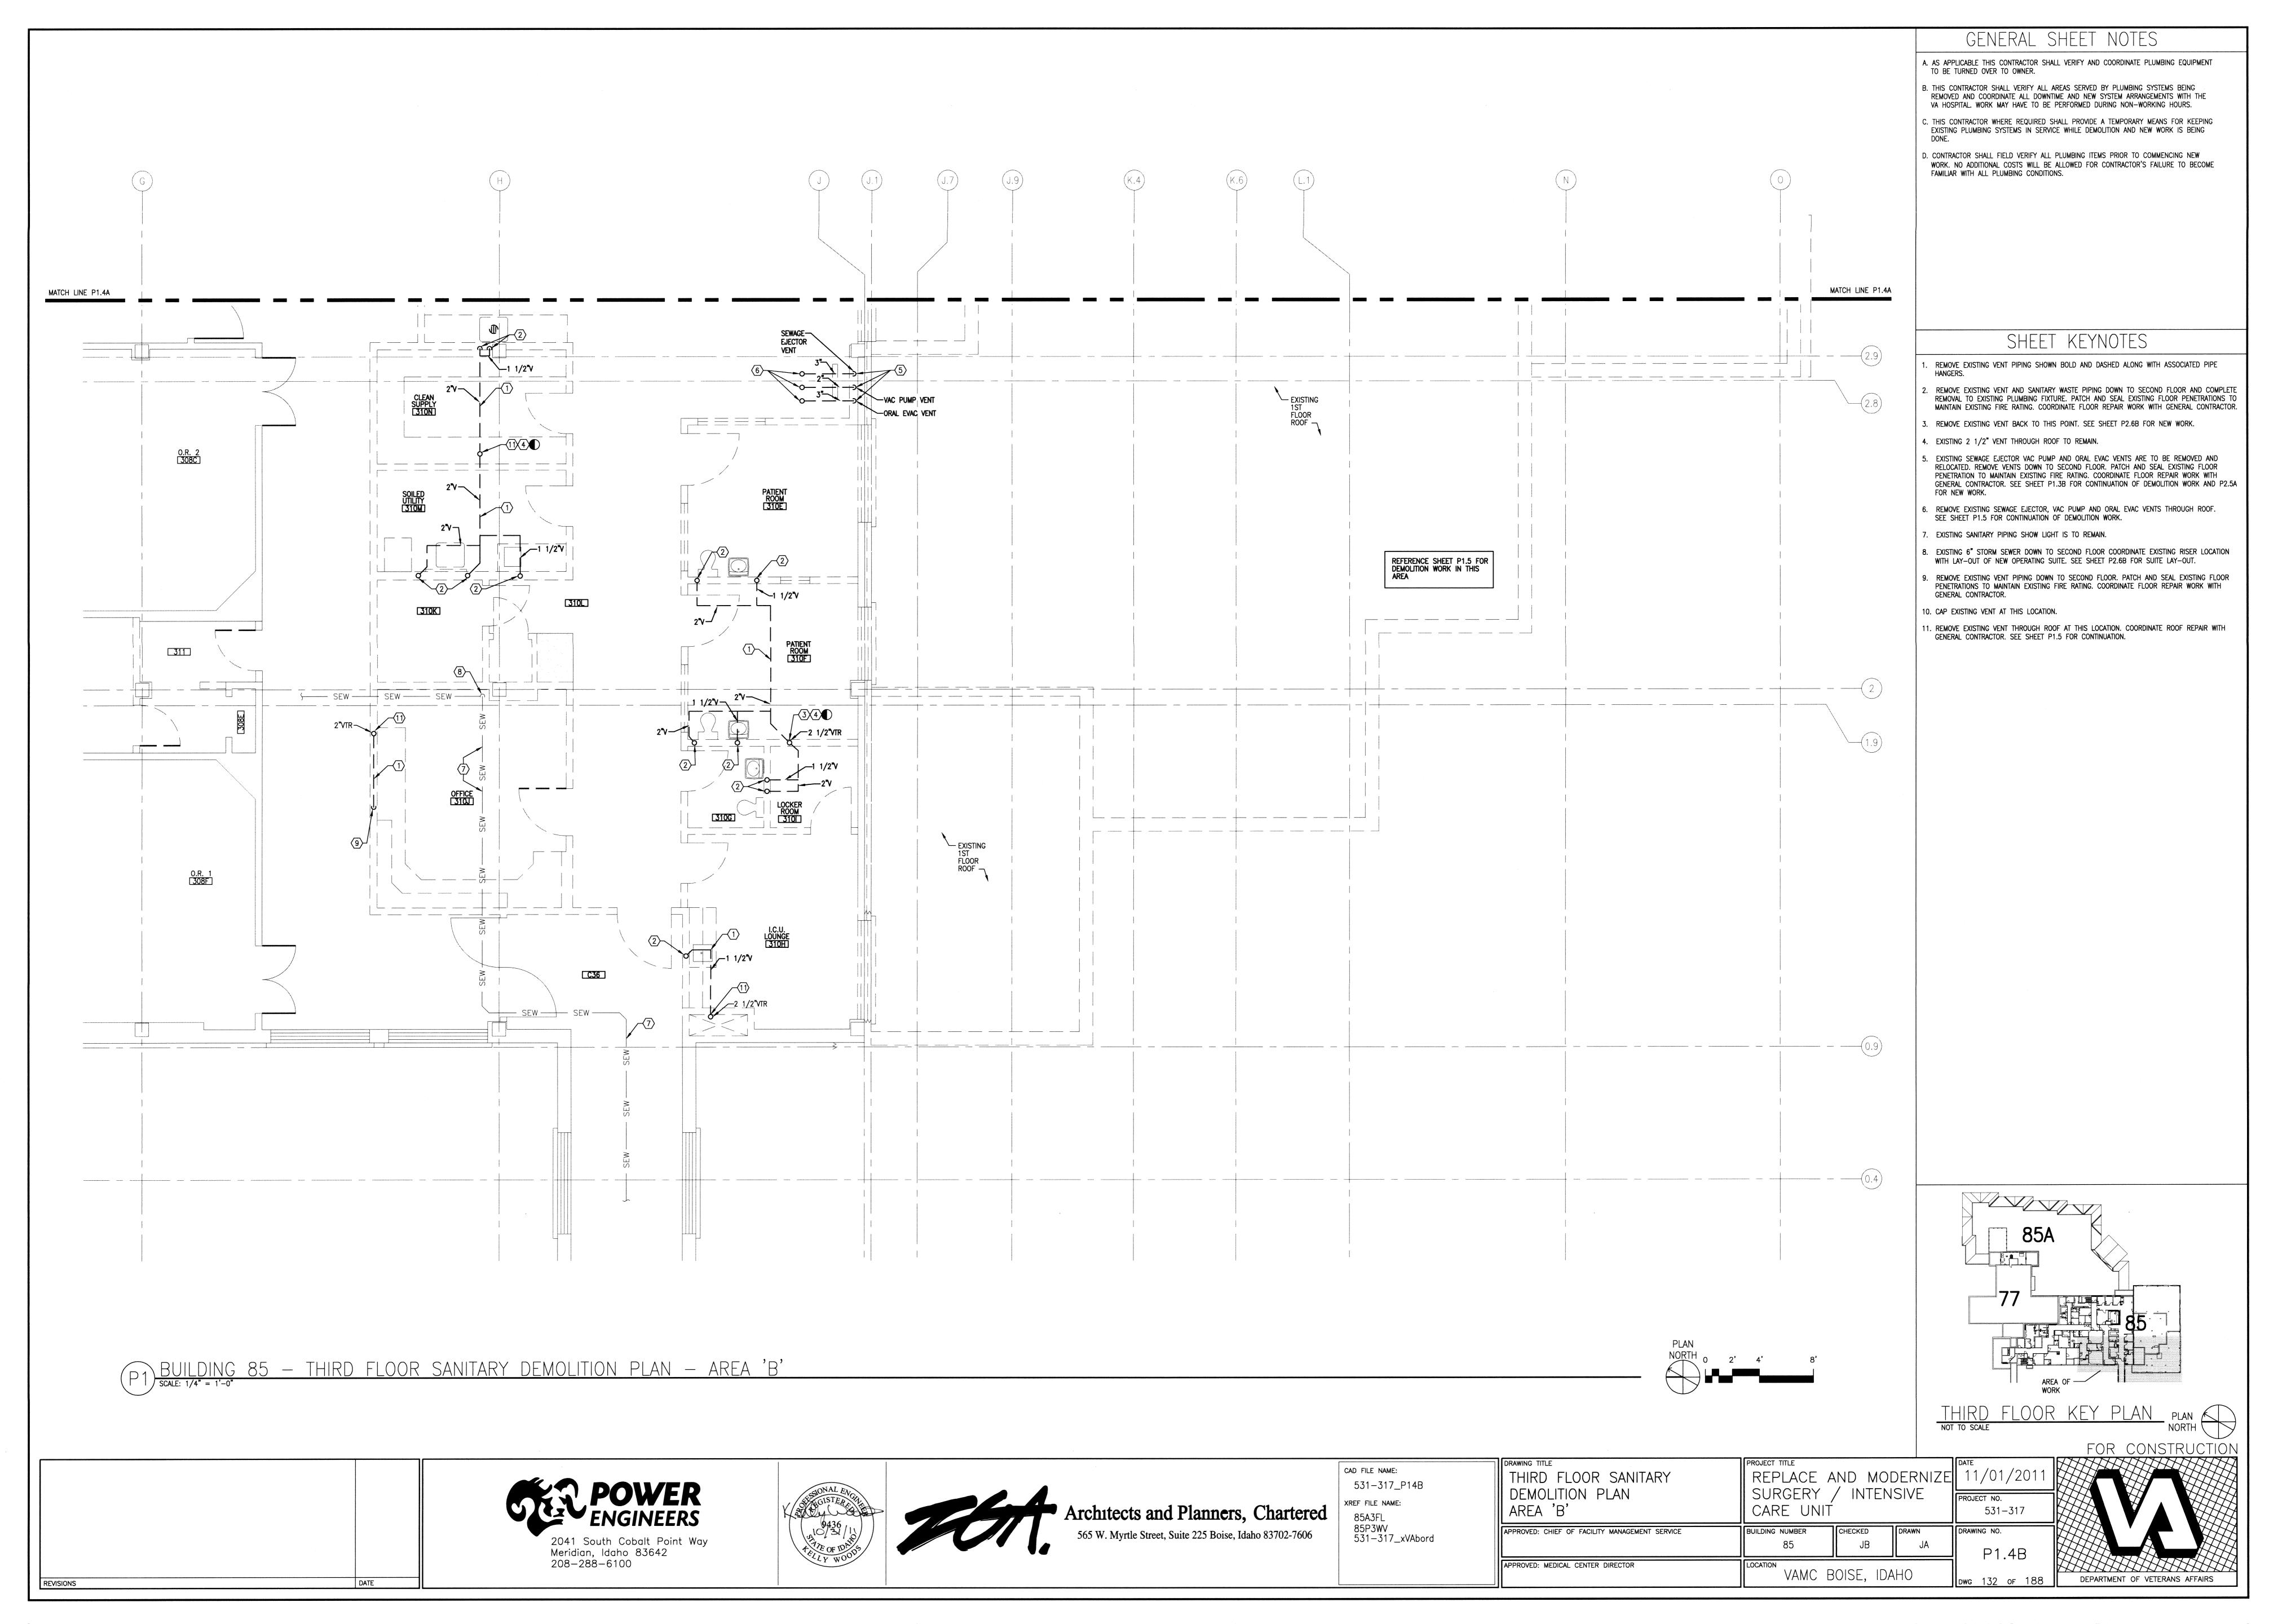

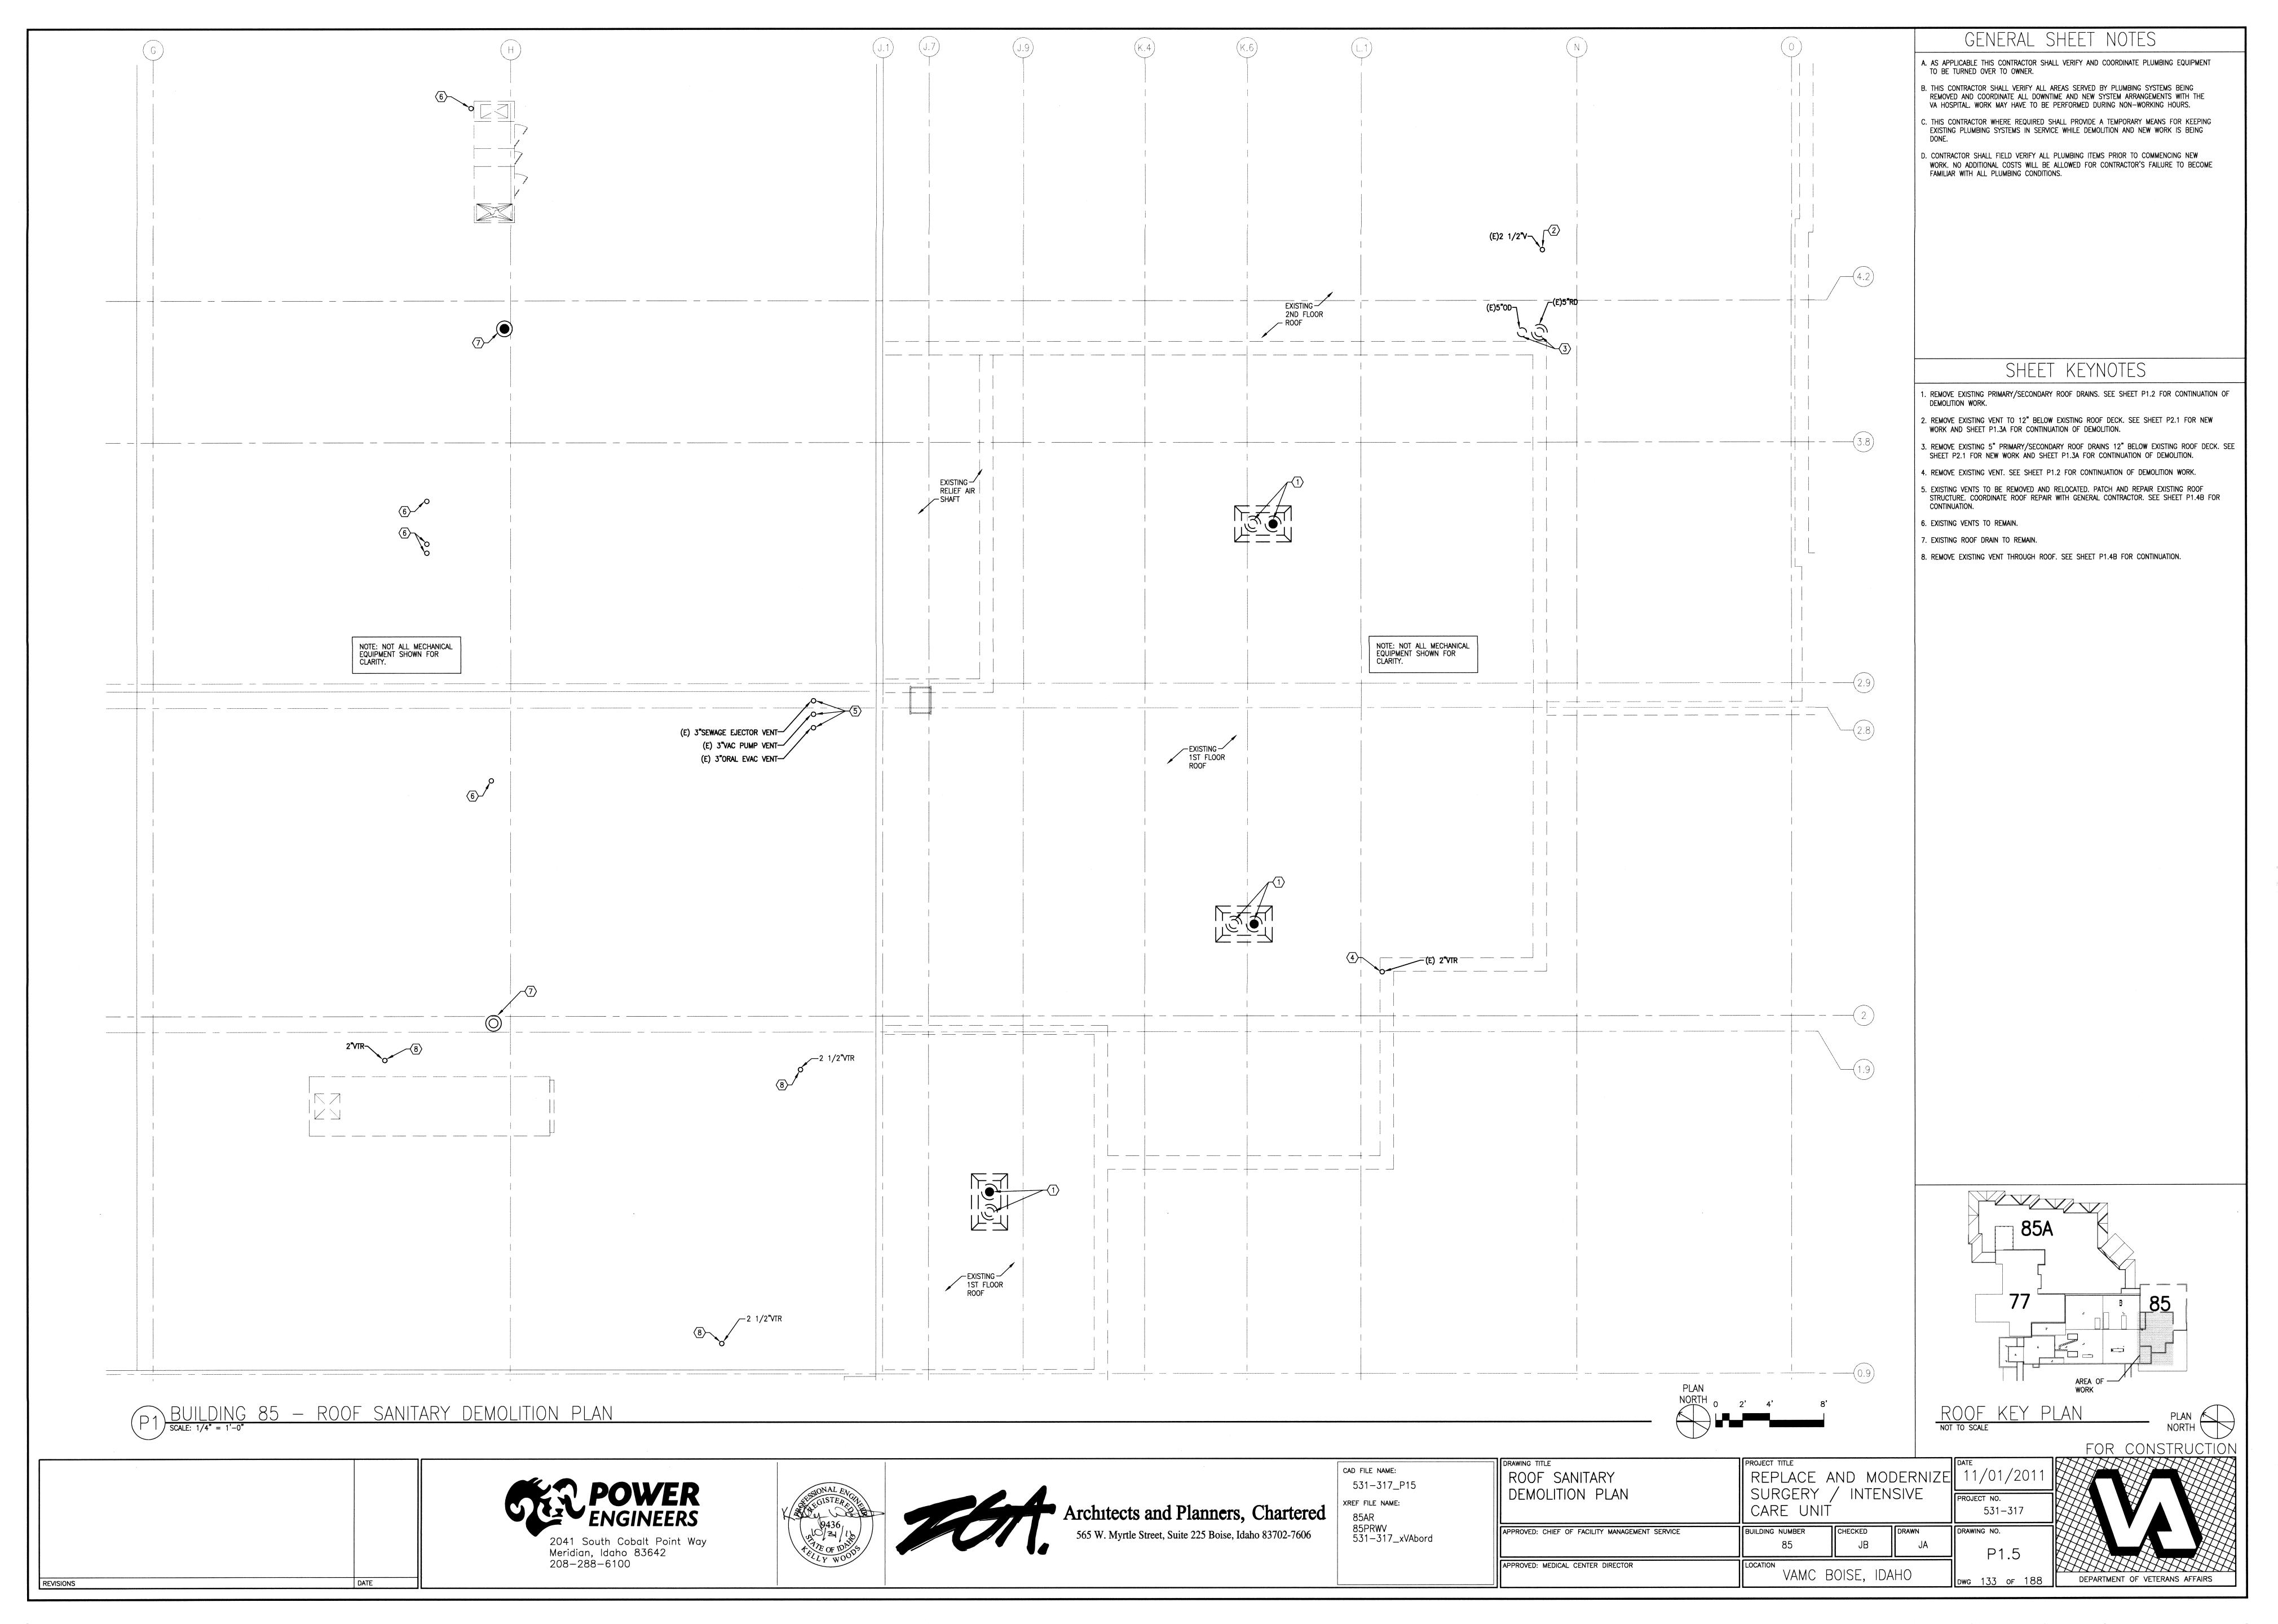

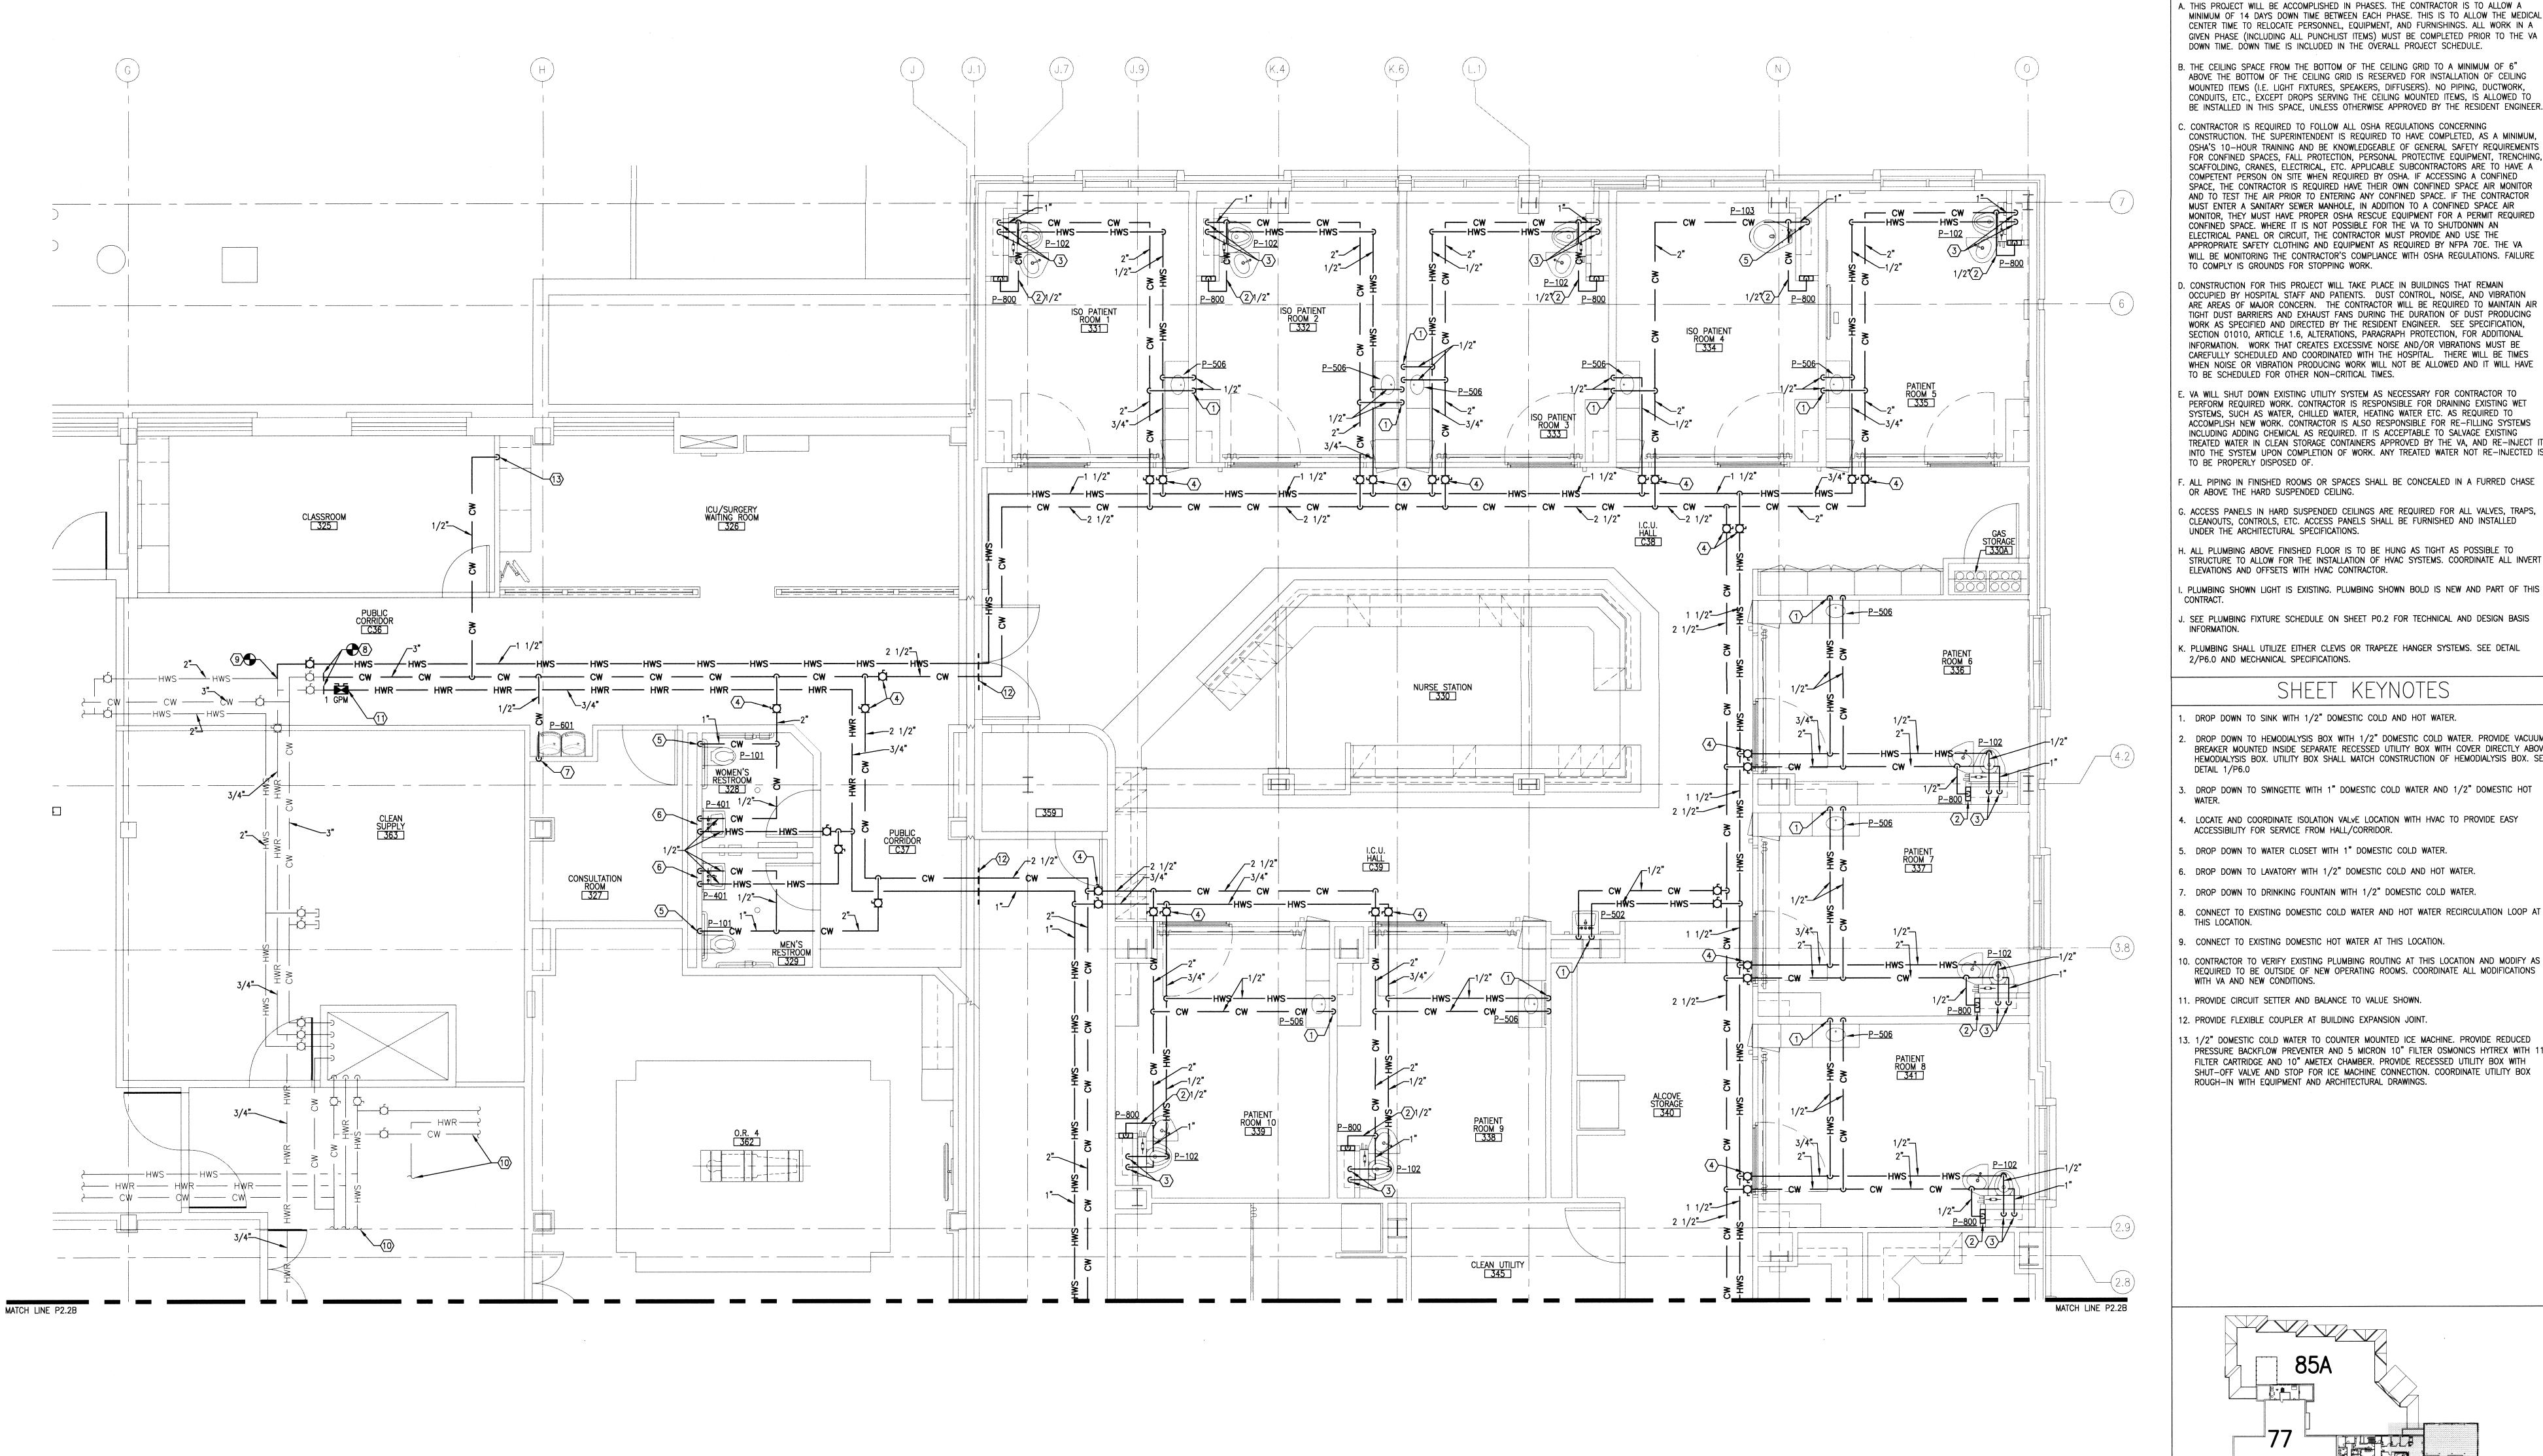

P2) BUILDING 85 - THIRD FLOOR PLUMBING PLAN - AREA 'A' scale: 1/4" = 1'-0"

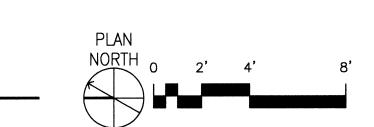

WILL BE MONITORING THE CONTRACTOR'S COMPLIANCE WITH OSHA REGULATIONS. FAILURE TO COMPLY IS GROUNDS FOR STOPPING WORK. . CONSTRUCTION FOR THIS PROJECT WILL TAKE PLACE IN BUILDINGS THAT REMAIN OCCUPIED BY HOSPITAL STAFF AND PATIENTS. DUST CONTROL, NOISE, AND VIBRATION ARE AREAS OF MAJOR CONCERN. THE CONTRACTOR WILL BE REQUIRED TO MAINTAIN AIR TIGHT DUST BARRIERS AND EXHAUST FANS DURING THE DURATION OF DUST PRODUCING WORK AS SPECIFIED AND DIRECTED BY THE RESIDENT ENGINEER. SEE SPECIFICATION, SECTION 01010, ARTICLE 1.6, ALTERATIONS, PARAGRAPH PROTECTION, FOR ADDITIONAL INFORMATION. WORK THAT CREATES EXCESSIVE NOISE AND/OR VIBRATIONS MUST BE CAREFULLY SCHEDULED AND COORDINATED WITH THE HOSPITAL. THERE WILL BE TIMES

E. VA WILL SHUT DOWN EXISTING UTILITY SYSTEM AS NECESSARY FOR CONTRACTOR TO PERFORM REQUIRED WORK. CONTRACTOR IS RESPONSIBLE FOR DRAINING EXISTING WET SYSTEMS, SUCH AS WATER, CHILLED WATER, HEATING WATER ETC. AS REQUIRED TO ACCOMPLISH NEW WORK. CONTRACTOR IS ALSO RESPONSIBLE FOR RE-FILLING SYSTEMS INCLUDING ADDING CHEMICAL AS REQUIRED. IT IS ACCEPTABLE TO SALVAGE EXISTING TREATED WATER IN CLEAN STORAGE CONTAINERS APPROVED BY THE VA, AND RE-INJECT INTO THE SYSTEM UPON COMPLETION OF WORK. ANY TREATED WATER NOT RE-INJECTED IS TO BE PROPERLY DISPOSED OF.

GENERAL SHEET NOTES

. ALL PIPING IN FINISHED ROOMS OR SPACES SHALL BE CONCEALED IN A FURRED CHASE OR ABOVE THE HARD SUSPENDED CEILING.

G. ACCESS PANELS IN HARD SUSPENDED CEILINGS ARE REQUIRED FOR ALL VALVES, TRAPS, CLEANOUTS, CONTROLS, ETC. ACCESS PANELS SHALL BE FURNISHED AND INSTALLED UNDER THE ARCHITECTURAL SPECIFICATIONS.

STRUCTURE TO ALLOW FOR THE INSTALLATION OF HVAC SYSTEMS. COORDINATE ALL INVERT ELEVATIONS AND OFFSETS WITH HVAC CONTRACTOR.

PLUMBING SHOWN LIGHT IS EXISTING. PLUMBING SHOWN BOLD IS NEW AND PART OF THIS . SEE PLUMBING FIXTURE SCHEDULE ON SHEET PO.2 FOR TECHNICAL AND DESIGN BASIS

K. PLUMBING SHALL UTILIZE EITHER CLEVIS OR TRAPEZE HANGER SYSTEMS. SEE DETAIL 2/P6.0 AND MECHANICAL SPECIFICATIONS.

SHEET KEYNOTES

DROP DOWN TO SINK WITH 1/2" DOMESTIC COLD AND HOT WATER.

DROP DOWN TO HEMODIALYSIS BOX WITH 1/2" DOMESTIC COLD WATER. PROVIDE VACUUM BREAKER MOUNTED INSIDE SEPARATE RECESSED UTILITY BOX WITH COVER DIRECTLY ABOVE HEMODIALYSIS BOX. UTILITY BOX SHALL MATCH CONSTRUCTION OF HEMODIALYSIS BOX. SEE DETAIL 1/P6.0

DROP DOWN TO SWINGETTE WITH 1" DOMESTIC COLD WATER AND 1/2" DOMESTIC HOT

LOCATE AND COORDINATE ISOLATION VALVE LOCATION WITH HVAC TO PROVIDE EASY ACCESSIBILITY FOR SERVICE FROM HALL/CORRIDOR.

5. DROP DOWN TO WATER CLOSET WITH 1" DOMESTIC COLD WATER.

6. DROP DOWN TO LAVATORY WITH 1/2" DOMESTIC COLD AND HOT WATER.

7. DROP DOWN TO DRINKING FOUNTAIN WITH 1/2" DOMESTIC COLD WATER. B. CONNECT TO EXISTING DOMESTIC COLD WATER AND HOT WATER RECIRCULATION LOOP AT


9. CONNECT TO EXISTING DOMESTIC HOT WATER AT THIS LOCATION.

10. CONTRACTOR TO VERIFY EXISTING PLUMBING ROUTING AT THIS LOCATION AND MODIFY AS REQUIRED TO BE OUTSIDE OF NEW OPERATING ROOMS. COORDINATE ALL MODIFICATIONS WITH VA AND NEW CONDITIONS.


11. PROVIDE CIRCUIT SETTER AND BALANCE TO VALUE SHOWN.

12. PROVIDE FLEXIBLE COUPLER AT BUILDING EXPANSION JOINT.

13. 1/2" DOMESTIC COLD WATER TO COUNTER MOUNTED ICE MACHINE. PROVIDE REDUCED PRESSURE BACKFLOW PREVENTER AND 5 MICRON 10" FILTER OSMONICS HYTREX WITH 11" FILTER CARTRIDGE AND 10" AMETEX CHAMBER. PROVIDE RECESSED UTILITY BOX WITH SHUT-OFF VALVE AND STOP FOR ICE MACHINE CONNECTION. COORDINATE UTILITY BOX ROUGH-IN WITH EQUIPMENT AND ARCHITECTURAL DRAWINGS.

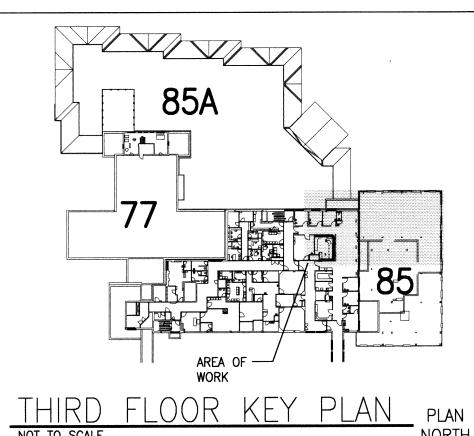

2041 South Cobalt Point Way Meridian, Idaho 83642 208-288-6100

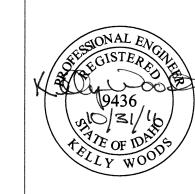

CAD FILE NAME: 531-317_P22A 85A3FL 85M3WA 531-317_xVAbord DRAWING TITLE
THIRD FLOOR REPLACE AND MODERNIZE PLUMBING PLAN SURGERY / INTENSIVE CARE UNIT AREA 'A'


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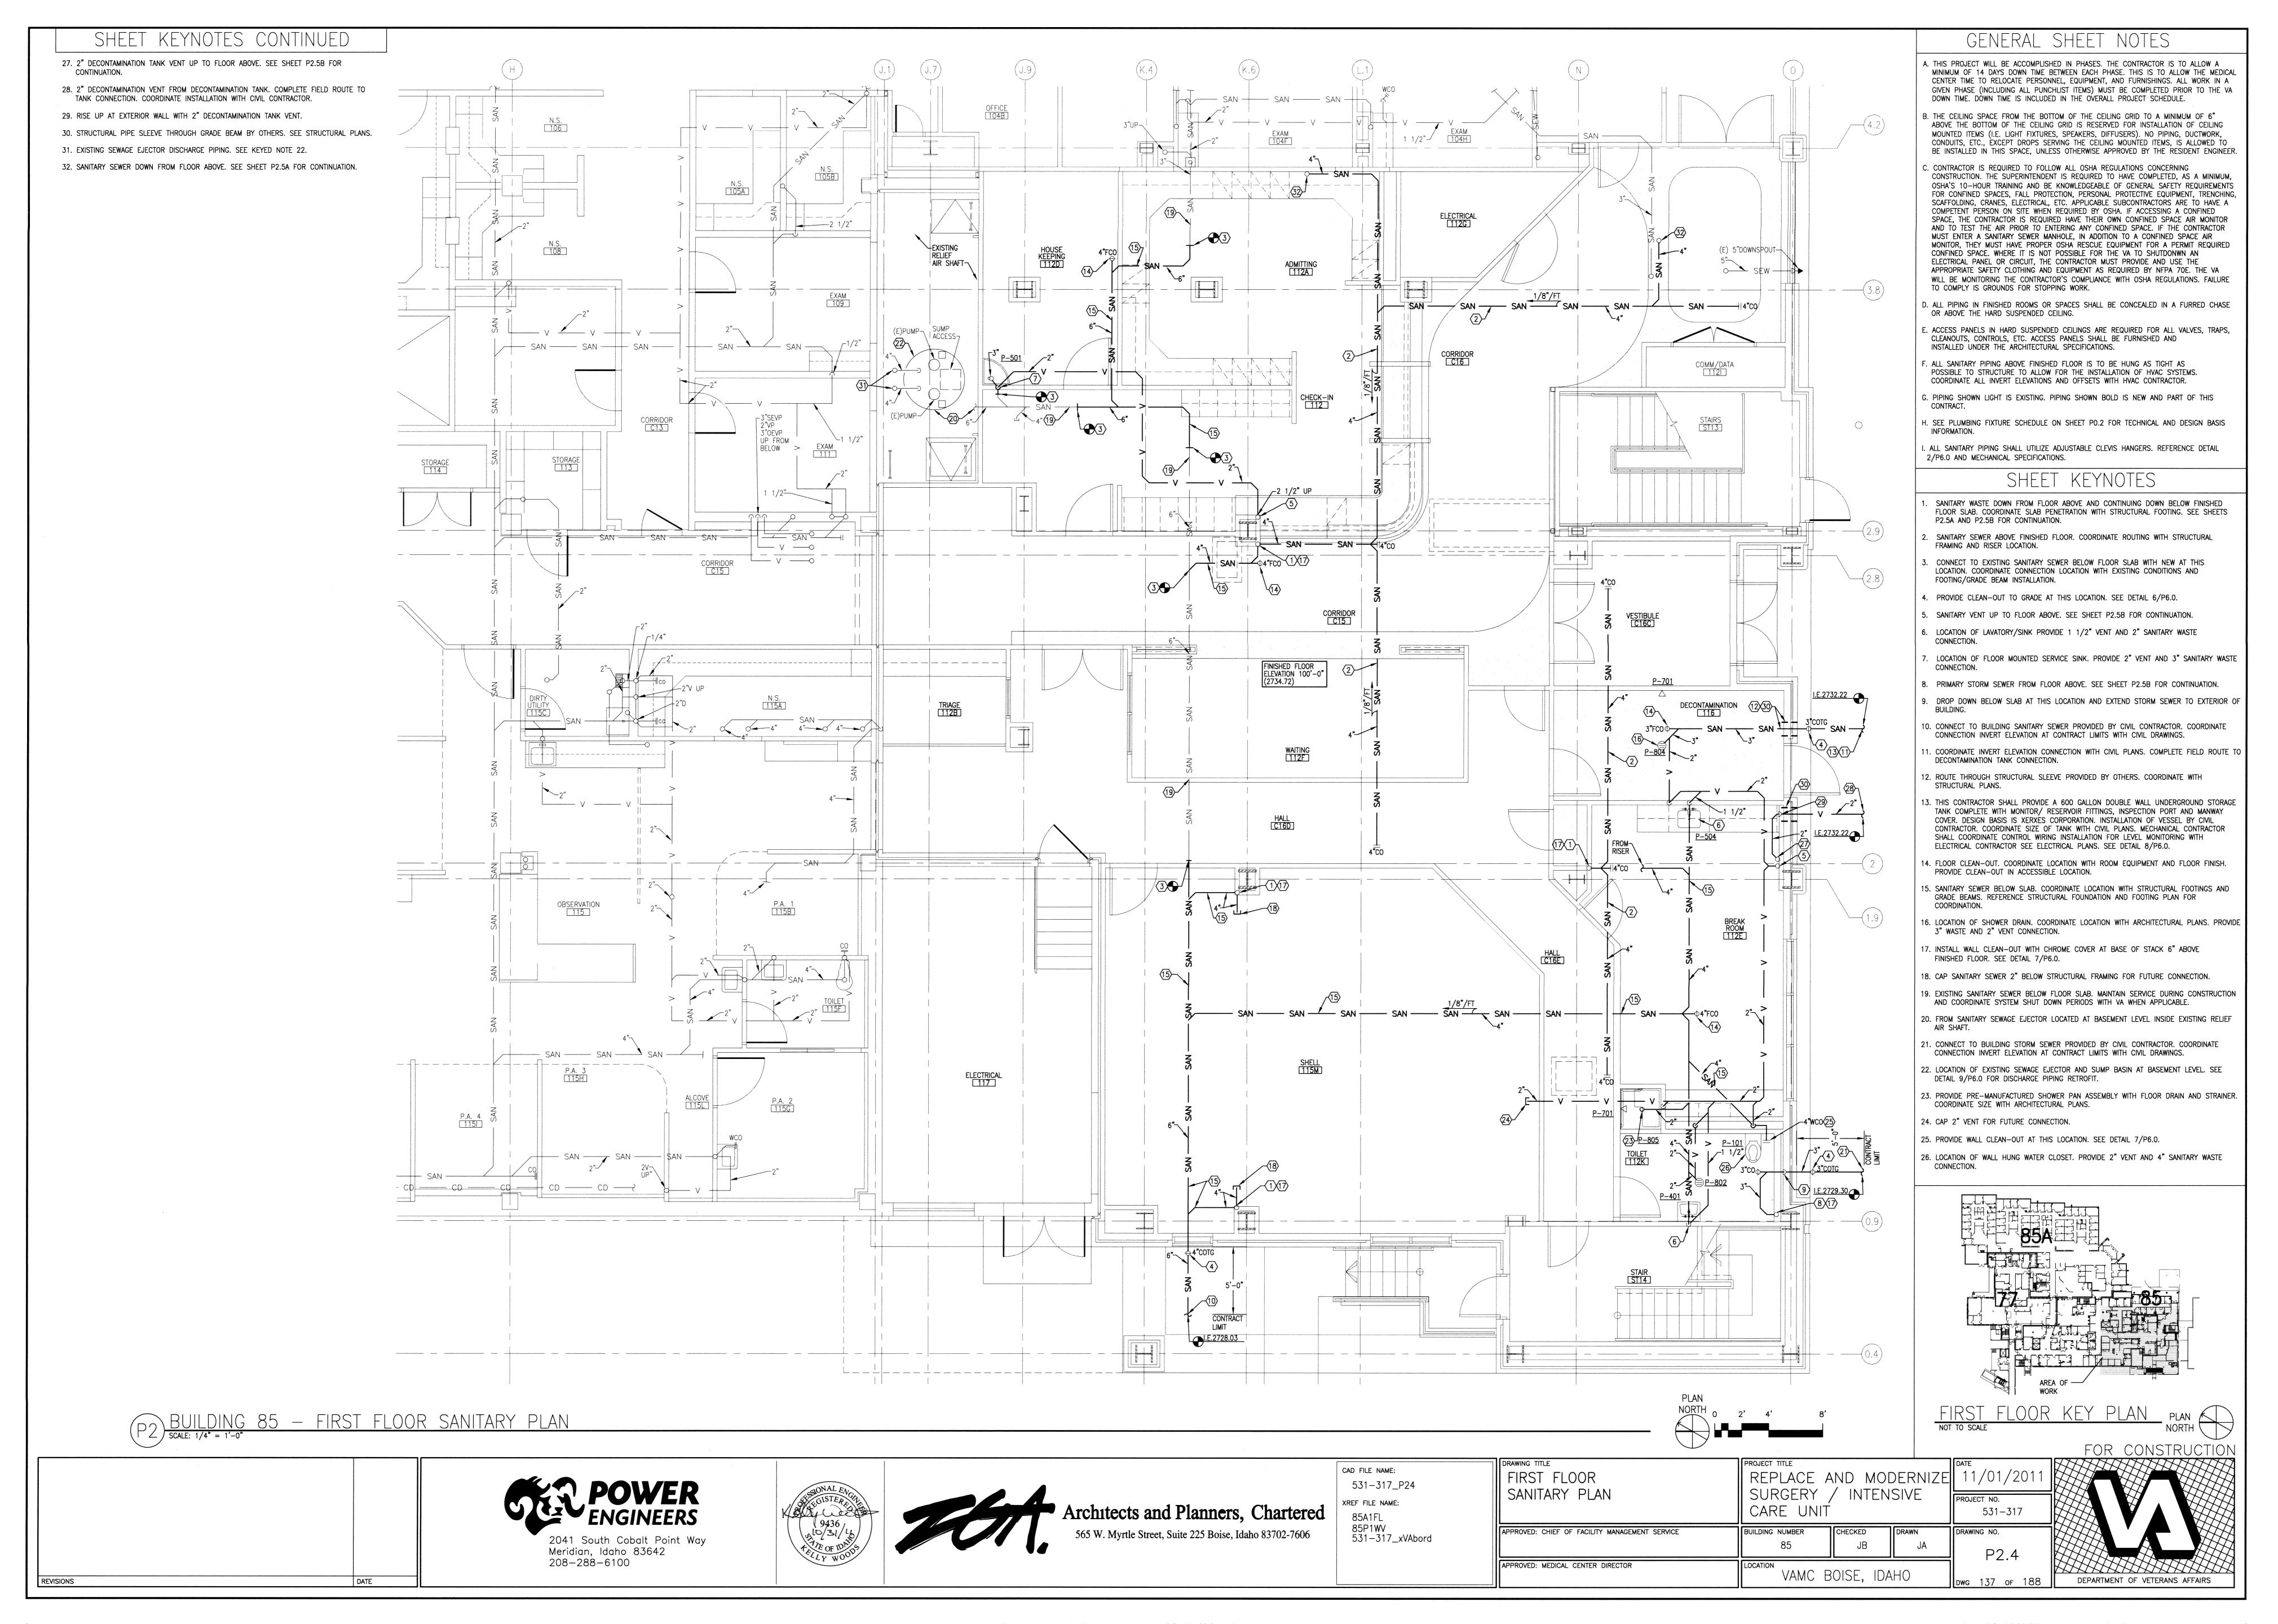
FOR CONSTRUCTION


DEPARTMENT OF VETERANS AFFAIRS

Architects and Planners, Chartered
565 W. Myrtle Street, Suite 225 Boise, Idaho 83702-7606

APPROVED: CHIEF OF FACILITY MANAGEMENT SERVICE APPROVED: MEDICAL CENTER DIRECTOR VAMC BOISE, IDAHO



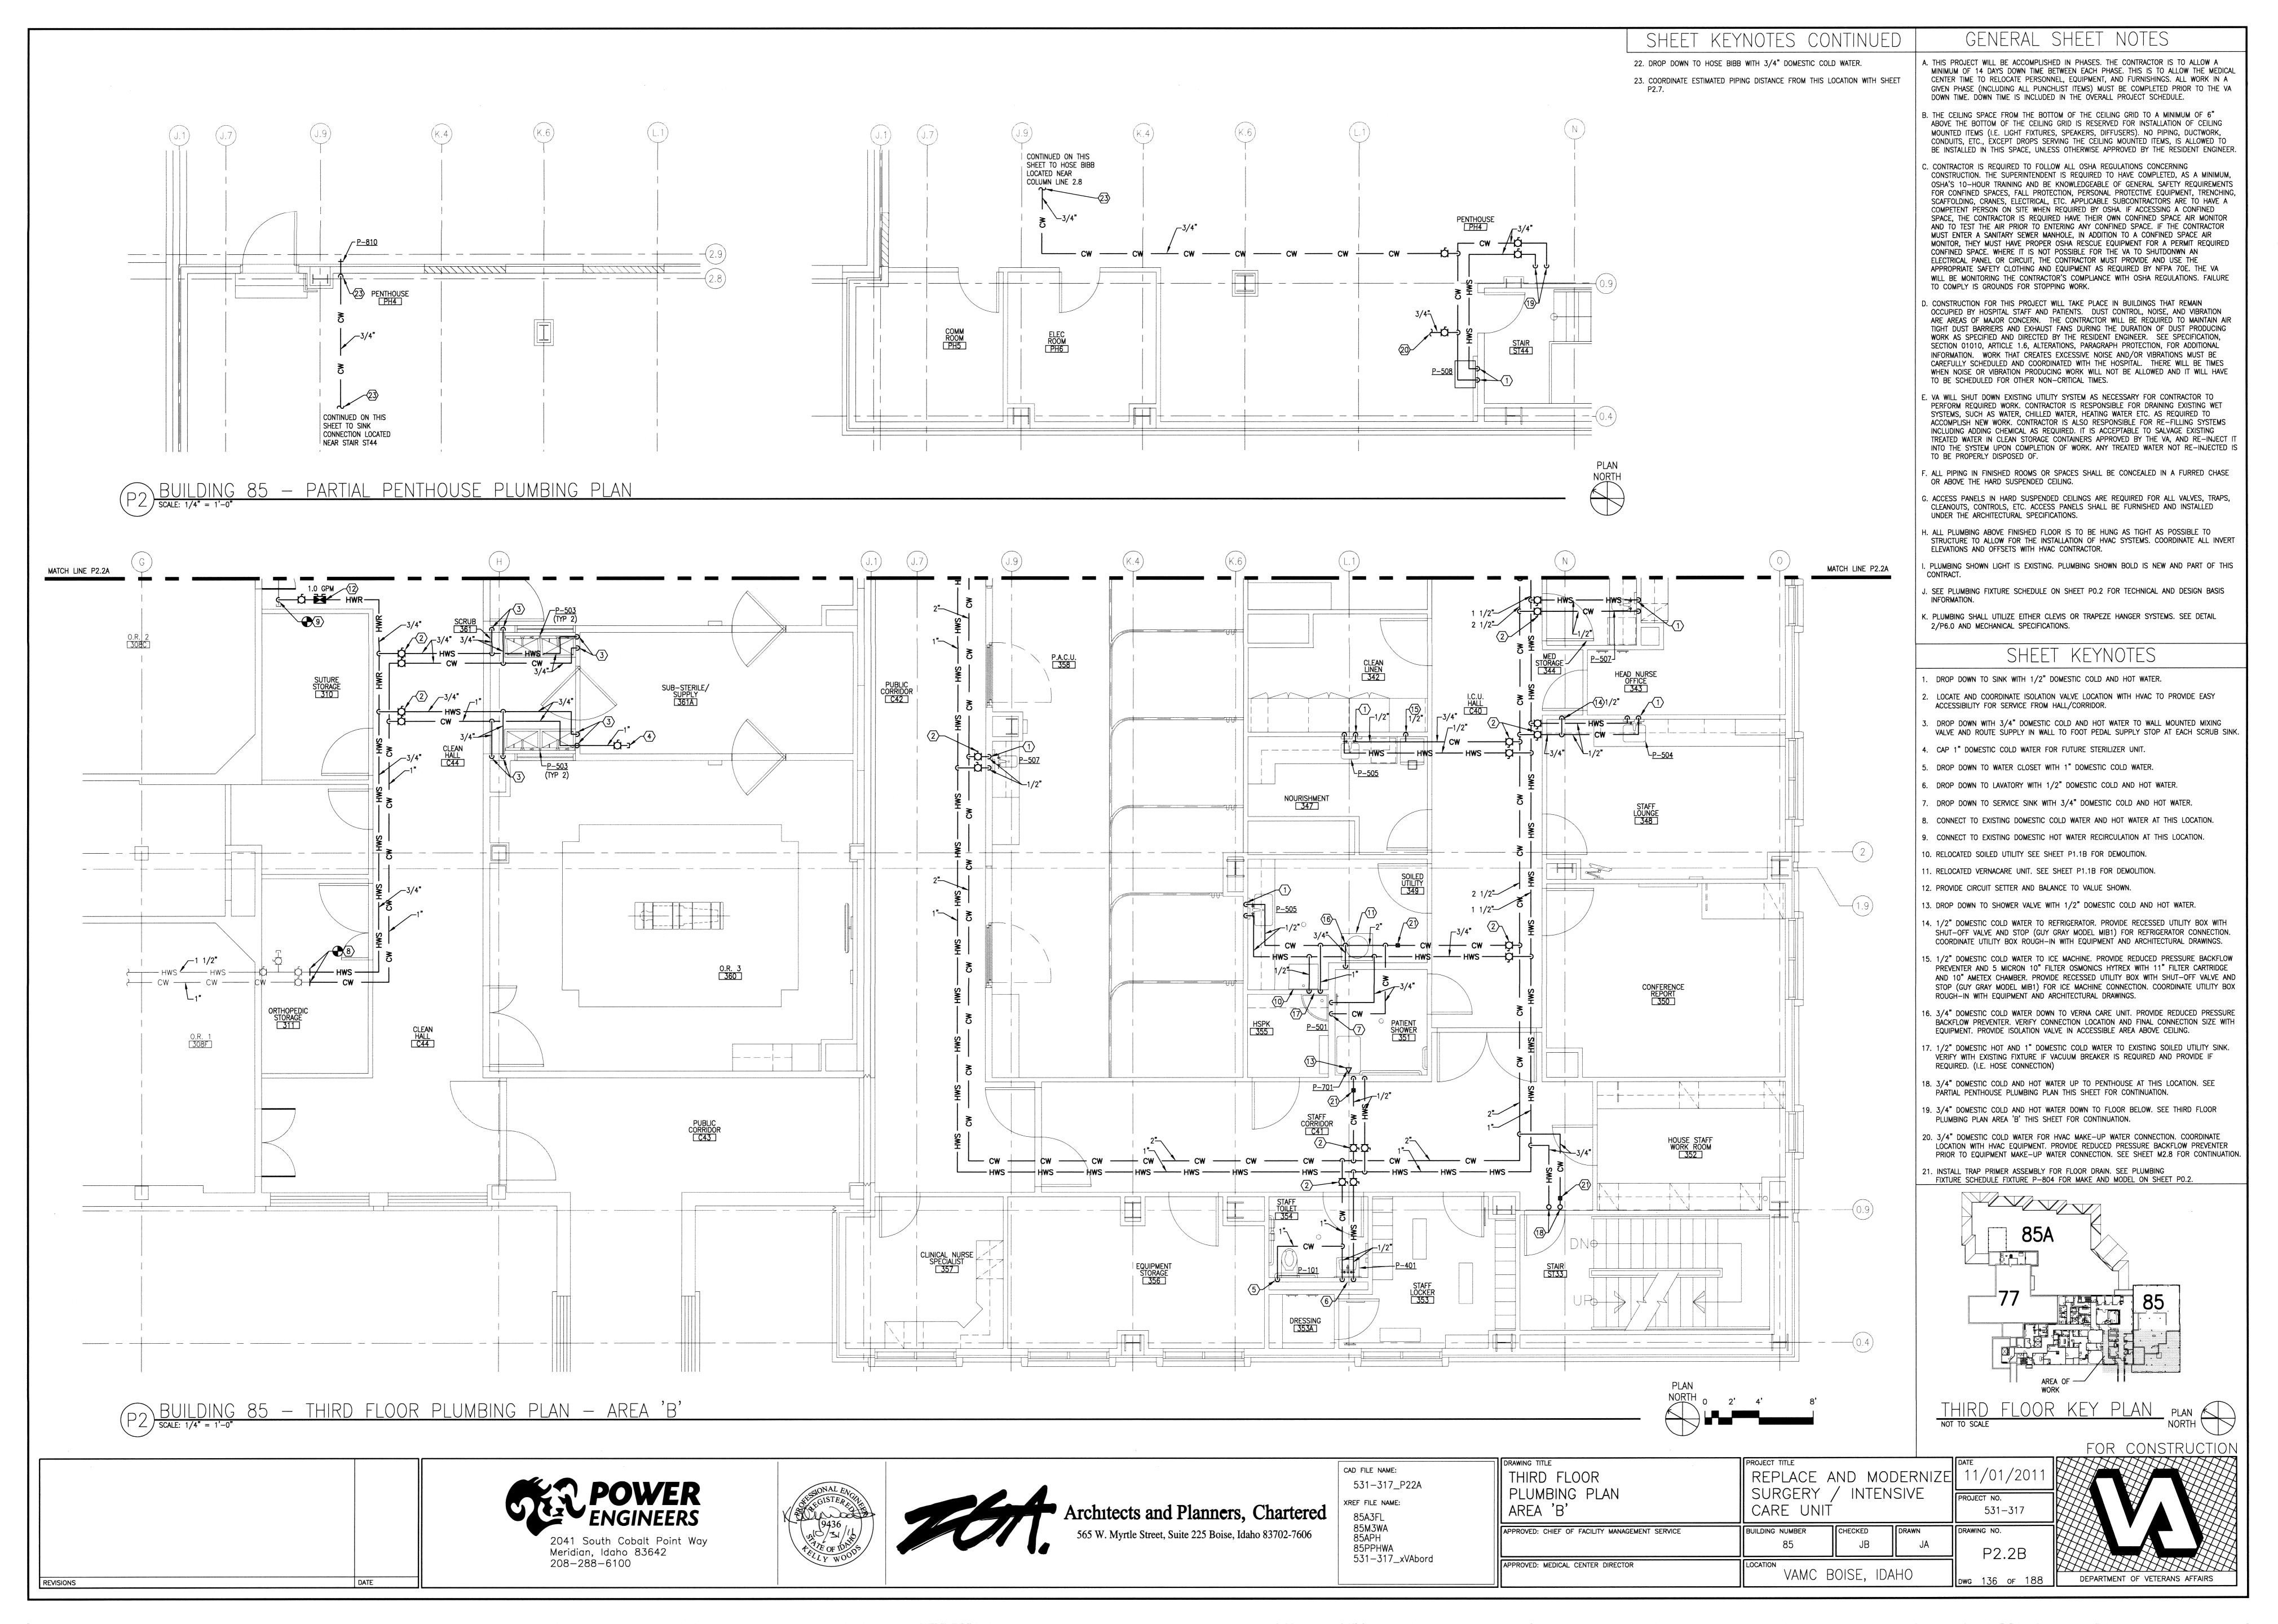


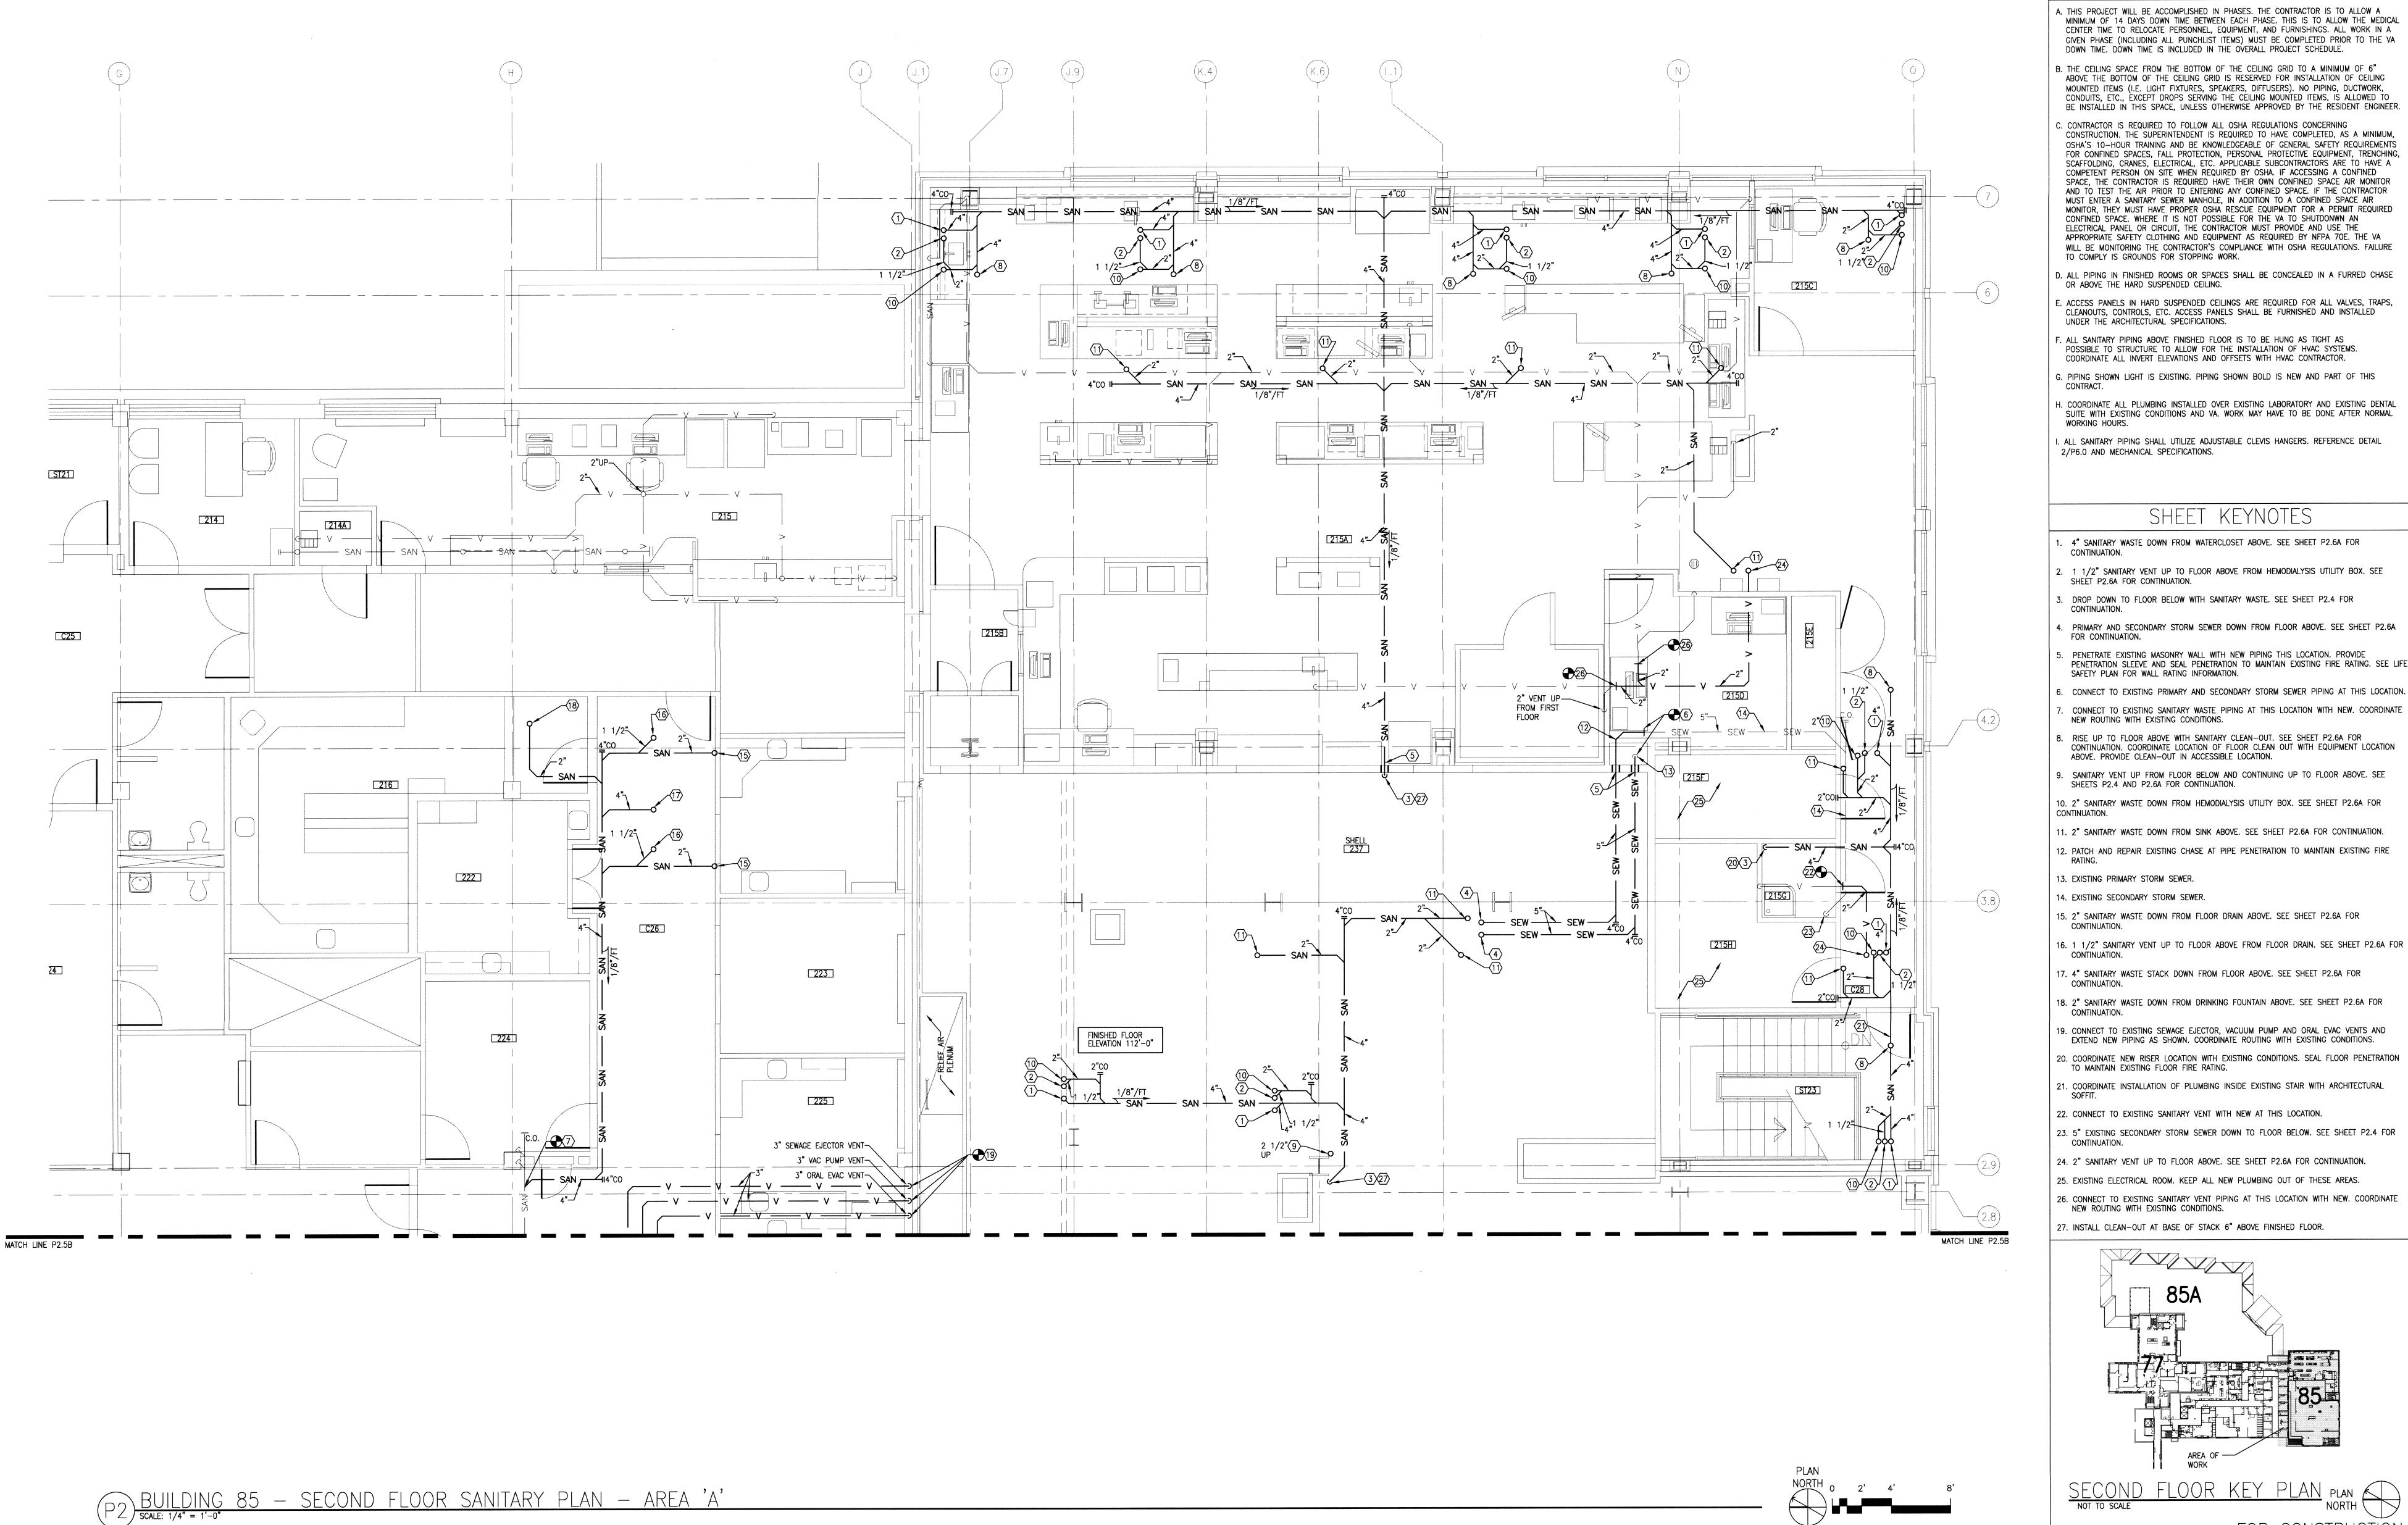


- A. THIS PROJECT WILL BE ACCOMPLISHED IN PHASES. THE CONTRACTOR IS TO ALLOW A MINIMUM OF 14 DAYS DOWN TIME BETWEEN EACH PHASE. THIS IS TO ALLOW THE MEDICAL CENTER TIME TO RELOCATE PERSONNEL, EQUIPMENT, AND FURNISHINGS. ALL WORK IN A GIVEN PHASE (INCLUDING ALL PUNCHLIST ITEMS) MUST BE COMPLETED PRIOR TO THE VA DOWN TIME. DOWN TIME IS INCLUDED IN THE OVERALL PROJECT SCHEDULE.
- B. THE CEILING SPACE FROM THE BOTTOM OF THE CEILING GRID TO A MINIMUM OF 6" ABOVE THE BOTTOM OF THE CEILING GRID IS RESERVED FOR INSTALLATION OF CEILING MOUNTED ITEMS (I.E. LIGHT FIXTURES, SPEAKERS, DIFFUSERS). NO PIPING, DUCTWORK, CONDUITS, ETC., EXCEPT DROPS SERVING THE CEILING MOUNTED ITEMS, IS ALLOWED TO
 - C. CONTRACTOR IS REQUIRED TO FOLLOW ALL OSHA REGULATIONS CONCERNING
 CONSTRUCTION. THE SUPERINTENDENT IS REQUIRED TO HAVE COMPLETED, AS A MINIMUM, OSHA'S 10-HOUR TRAINING AND BE KNOWLEDGEABLE OF GENERAL SAFETY REQUIREMENTS FOR CONFINED SPACES, FALL PROTECTION, PERSONAL PROTECTIVE EQUIPMENT, TRENCHING, SCAFFOLDING, CRANES, ELECTRICAL, ETC. APPLICABLE SUBCONTRACTORS ARE TO HAVE A COMPETENT PERSON ON SITE WHEN REQUIRED BY OSHA. IF ACCESSING A CONFINED SPACE, THE CONTRACTOR IS REQUIRED HAVE THEIR OWN CONFINED SPACE AIR MONITOR AND TO TEST THE AIR PRIOR TO ENTERING ANY CONFINED SPACE. IF THE CONTRACTOR MUST ENTER A SANITARY SEWER MANHOLE, IN ADDITION TO A CONFINED SPACE AIR MONITOR, THEY MUST HAVE PROPER OSHA RESCUE EQUIPMENT FOR A PERMIT REQUIRED CONFINED SPACE. WHERE IT IS NOT POSSIBLE FOR THE VA TO SHUTDONWN AN ELECTRICAL PANEL OR CIRCUIT, THE CONTRACTOR MUST PROVIDE AND USE THE APPROPRIATE SAFETY CLOTHING AND EQUIPMENT AS REQUIRED BY NFPA 70E. THE VA WILL BE MONITORING THE CONTRACTOR'S COMPLIANCE WITH OSHA REGULATIONS. FAILURE TO COMPLY IS GROUNDS FOR STOPPING WORK.
 - D. ALL PIPING IN FINISHED ROOMS OR SPACES SHALL BE CONCEALED IN A FURRED CHASE OR ABOVE THE HARD SUSPENDED CEILING.
 - . ACCESS PANELS IN HARD SUSPENDED CEILINGS ARE REQUIRED FOR ALL VALVES, TRAPS, CLEANOUTS, CONTROLS, ETC. ACCESS PANELS SHALL BE FURNISHED AND INSTALLED UNDER THE ARCHITECTURAL SPECIFICATIONS.
 - F. ALL SANITARY PIPING ABOVE FINISHED FLOOR IS TO BE HUNG AS TIGHT AS POSSIBLE TO STRUCTURE TO ALLOW FOR THE INSTALLATION OF HVAC SYSTEMS. COORDINATE ALL INVERT ELEVATIONS AND OFFSETS WITH HVAC CONTRACTOR.
- G. PIPING SHOWN LIGHT IS EXISTING. PIPING SHOWN BOLD IS NEW AND PART OF THIS
- H. COORDINATE ALL PLUMBING INSTALLED OVER EXISTING LABORATORY AND EXISTING DENTAL SUITE WITH EXISTING CONDITIONS AND VA. WORK MAY HAVE TO BE DONE AFTER NORMAL WORKING HOURS.
- ALL SANITARY PIPING SHALL UTILIZE ADJUSTABLE CLEVIS HANGERS. REFERENCE DETAIL 2/P6.0 AND MECHANICAL SPECIFICATIONS.


SHEET KEYNOTES

- 4" SANITARY WASTE DOWN FROM WATERCLOSET ABOVE. SEE SHEET P2.6A FOR
- 2. 1 1/2" SANITARY VENT UP TO FLOOR ABOVE FROM HEMODIALYSIS UTILITY BOX. SEE SHEET P2.6A FOR CONTINUATION.
- . DROP DOWN TO FLOOR BELOW WITH SANITARY WASTE. SEE SHEET P2.4 FOR CONTINUATION.
- . PRIMARY AND SECONDARY STORM SEWER DOWN FROM FLOOR ABOVE. SEE SHEET P2.6A
- FOR CONTINUATION.
- PENETRATE EXISTING MASONRY WALL WITH NEW PIPING THIS LOCATION. PROVIDE PENETRATION SLEEVE AND SEAL PENETRATION TO MAINTAIN EXISTING FIRE RATING. SEE LIFE
- SAFETY PLAN FOR WALL RATING INFORMATION. 6. CONNECT TO EXISTING PRIMARY AND SECONDARY STORM SEWER PIPING AT THIS LOCATION.
- CONNECT TO EXISTING SANITARY WASTE PIPING AT THIS LOCATION WITH NEW. COORDINATE NEW ROUTING WITH EXISTING CONDITIONS. RISE UP TO FLOOR ABOVE WITH SANITARY CLEAN-OUT. SEE SHEET P2.6A FOR
- CONTINUATION. COORDINATE LOCATION OF FLOOR CLEAN OUT WITH EQUIPMENT LOCATION ABOVE. PROVIDE CLEAN-OUT IN ACCESSIBLE LOCATION.
- SANITARY VENT UP FROM FLOOR BELOW AND CONTINUING UP TO FLOOR ABOVE. SEE SHEETS P2.4 AND P2.6A FOR CONTINUATION.
- 11. 2" SANITARY WASTE DOWN FROM SINK ABOVE. SEE SHEET P2.6A FOR CONTINUATION.
- 12. PATCH AND REPAIR EXISTING CHASE AT PIPE PENETRATION TO MAINTAIN EXISTING FIRE
- 13. EXISTING PRIMARY STORM SEWER.
- 14. EXISTING SECONDARY STORM SEWER.
- 15. 2" SANITARY WASTE DOWN FROM FLOOR DRAIN ABOVE. SEE SHEET P2.6A FOR CONTINUATION.
- 17. 4" SANITARY WASTE STACK DOWN FROM FLOOR ABOVE. SEE SHEET P2.6A FOR CONTINUATION.
- 18. 2" SANITARY WASTE DOWN FROM DRINKING FOUNTAIN ABOVE. SEE SHEET P2.6A FOR CONTINUATION.
- 19. CONNECT TO EXISTING SEWAGE EJECTOR, VACUUM PUMP AND ORAL EVAC VENTS AND EXTEND NEW PIPING AS SHOWN. COORDINATE ROUTING WITH EXISTING CONDITIONS.
- 20. COORDINATE NEW RISER LOCATION WITH EXISTING CONDITIONS. SEAL FLOOR PENETRATION TO MAINTAIN EXISTING FLOOR FIRE RATING.
- 21. COORDINATE INSTALLATION OF PLUMBING INSIDE EXISTING STAIR WITH ARCHITECTURAL
- 22. CONNECT TO EXISTING SANITARY VENT WITH NEW AT THIS LOCATION.
- 23. 5" EXISTING SECONDARY STORM SEWER DOWN TO FLOOR BELOW. SEE SHEET P2.4 FOR
- 24. 2" SANITARY VENT UP TO FLOOR ABOVE. SEE SHEET P2.6A FOR CONTINUATION.
- 25. EXISTING ELECTRICAL ROOM. KEEP ALL NEW PLUMBING OUT OF THESE AREAS.
- 26. CONNECT TO EXISTING SANITARY VENT PIPING AT THIS LOCATION WITH NEW. COORDINATE NEW ROUTING WITH EXISTING CONDITIONS.
- 27. INSTALL CLEAN-OUT AT BASE OF STACK 6" ABOVE FINISHED FLOOR.

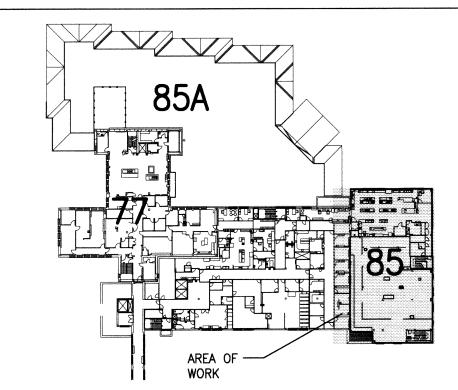

FOR CONSTRUCTION

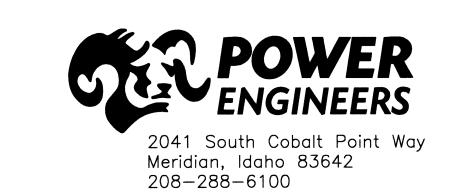

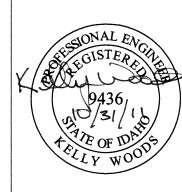



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CAD FILE NAME: 531-317_P2.5A XREF FILE NAME: 85A2FL 85P2WV 531–317_xVAbord


REPLACE AND MODERNIZE 11/01/201 SECOND FLOOR INTENSIVE SANITARY PLAN CARE UNIT AREA 'A'

APPROVED: CHIEF OF FACILITY MANAGEMENT SERVICE APPROVED: MEDICAL CENTER DIRECTOR

VAMC BOISE, IDAHO

531-317




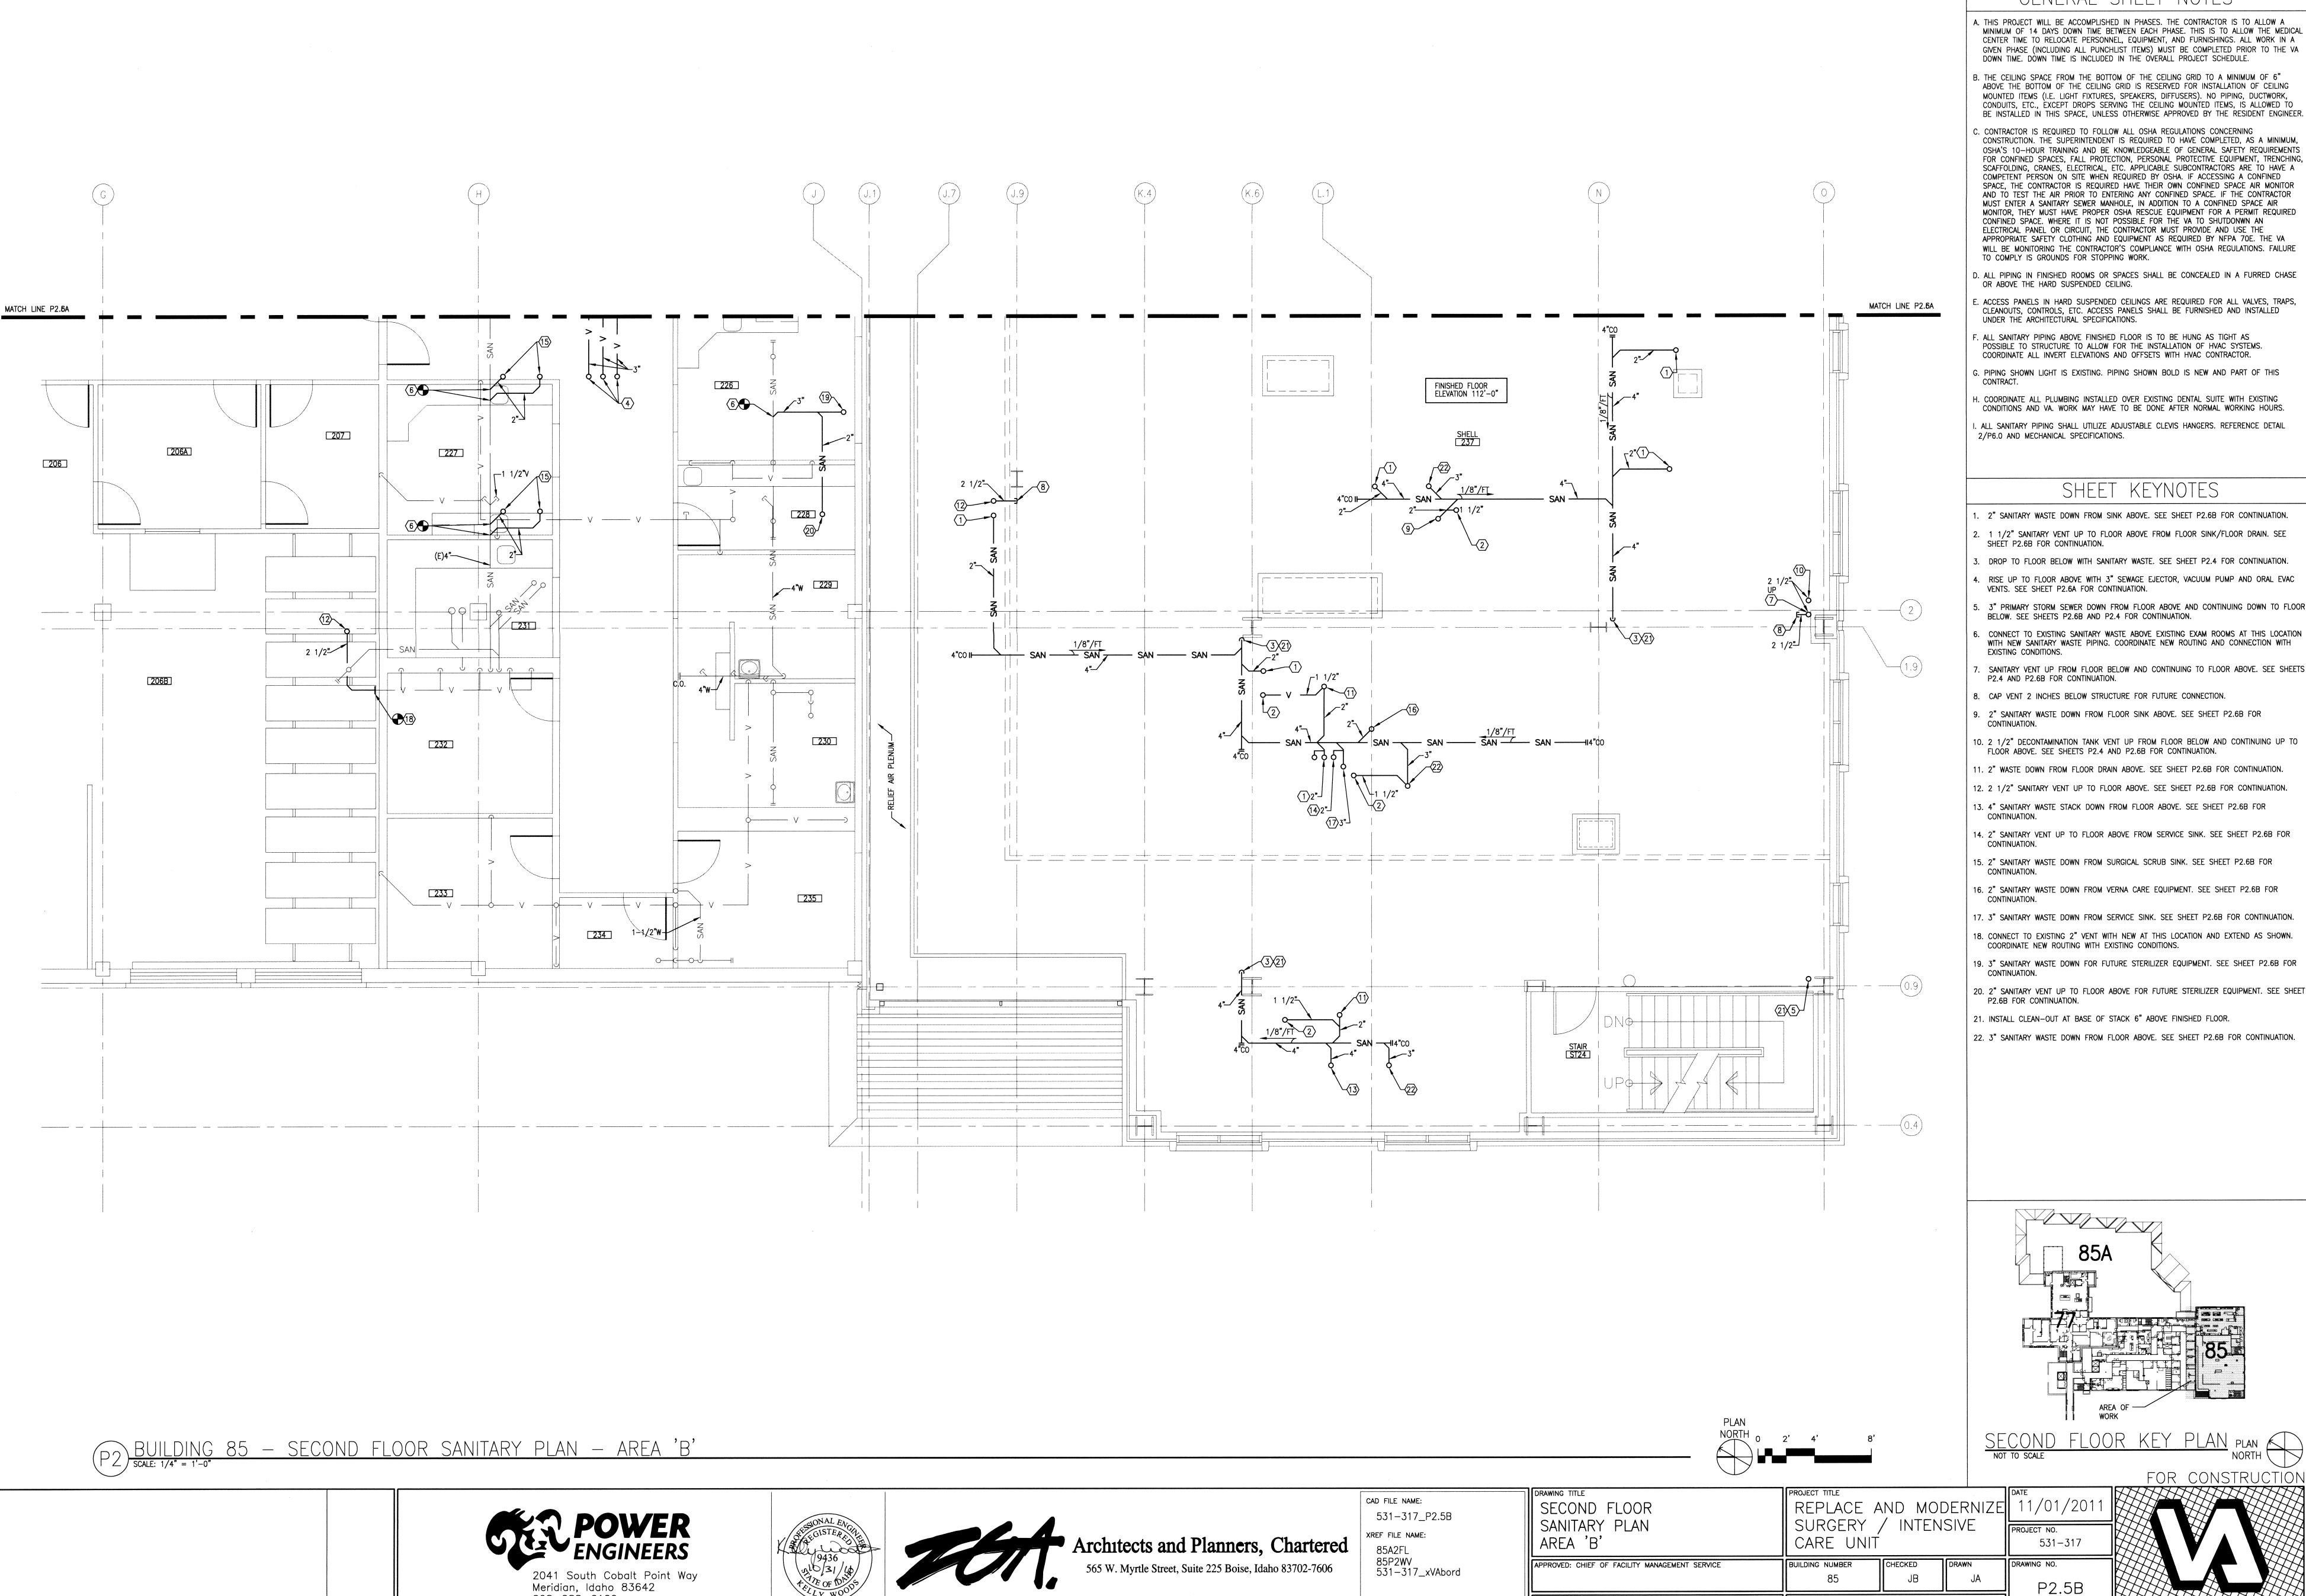

- A. THIS PROJECT WILL BE ACCOMPLISHED IN PHASES. THE CONTRACTOR IS TO ALLOW A MINIMUM OF 14 DAYS DOWN TIME BETWEEN EACH PHASE. THIS IS TO ALLOW THE MEDICAL CENTER TIME TO RELOCATE PERSONNEL, EQUIPMENT, AND FURNISHINGS. ALL WORK IN A GIVEN PHASE (INCLUDING ALL PUNCHLIST ITEMS) MUST BE COMPLETED PRIOR TO THE VA DOWN TIME. DOWN TIME IS INCLUDED IN THE OVERALL PROJECT SCHEDULE.
- B. THE CEILING SPACE FROM THE BOTTOM OF THE CEILING GRID TO A MINIMUM OF 6" ABOVE THE BOTTOM OF THE CEILING GRID IS RESERVED FOR INSTALLATION OF CEILING MOUNTED ITEMS (I.E. LIGHT FIXTURES, SPEAKERS, DIFFUSERS). NO PIPING, DUCTWORK,
 - . CONTRACTOR IS REQUIRED TO FOLLOW ALL OSHA REGULATIONS CONCERNING CONSTRUCTION. THE SUPERINTENDENT IS REQUIRED TO HAVE COMPLETED, AS A MINIMUM, OSHA'S 10-HOUR TRAINING AND BE KNOWLEDGEABLE OF GENERAL SAFETY REQUIREMENTS FOR CONFINED SPACES, FALL PROTECTION, PERSONAL PROTECTIVE EQUIPMENT, TRENCHING, SCAFFOLDING, CRANES, ELECTRICAL, ETC. APPLICABLE SUBCONTRACTORS ARE TO HAVE A COMPETENT PERSON ON SITE WHEN REQUIRED BY OSHA. IF ACCESSING A CONFINED SPACE, THE CONTRACTOR IS REQUIRED HAVE THEIR OWN CONFINED SPACE AIR MONITOR AND TO TEST THE AIR PRIOR TO ENTERING ANY CONFINED SPACE. IF THE CONTRACTOR MUST ENTER A SANITARY SEWER MANHOLE, IN ADDITION TO A CONFINED SPACE AIR MONITOR, THEY MUST HAVE PROPER OSHA RESCUE EQUIPMENT FOR A PERMIT REQUIRED CONFINED SPACE. WHERE IT IS NOT POSSIBLE FOR THE VA TO SHUTDONWN AN ELECTRICAL PANEL OR CIRCUIT, THE CONTRACTOR MUST PROVIDE AND USE THE APPROPRIATE SAFETY CLOTHING AND EQUIPMENT AS REQUIRED BY NFPA 70E. THE VA WILL BE MONITORING THE CONTRACTOR'S COMPLIANCE WITH OSHA REGULATIONS. FAILURE
 - D. ALL PIPING IN FINISHED ROOMS OR SPACES SHALL BE CONCEALED IN A FURRED CHASE OR ABOVE THE HARD SUSPENDED CEILING.
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 - T. ALL SANITARY PIPING ABOVE FINISHED FLOOR IS TO BE HUNG AS TIGHT AS POSSIBLE TO STRUCTURE TO ALLOW FOR THE INSTALLATION OF HVAC SYSTEMS. COORDINATE ALL INVERT ELEVATIONS AND OFFSETS WITH HVAC CONTRACTOR.
 - G. PIPING SHOWN LIGHT IS EXISTING. PIPING SHOWN BOLD IS NEW AND PART OF THIS
 - H. COORDINATE ALL PLUMBING INSTALLED OVER EXISTING DENTAL SUITE WITH EXISTING CONDITIONS AND VA. WORK MAY HAVE TO BE DONE AFTER NORMAL WORKING HOURS.
 - . ALL SANITARY PIPING SHALL UTILIZE ADJUSTABLE CLEVIS HANGERS. REFERENCE DETAIL 2/P6.0 AND MECHANICAL SPECIFICATIONS.

SHEET KEYNOTES

- . 2" SANITARY WASTE DOWN FROM SINK ABOVE. SEE SHEET P2.6B FOR CONTINUATION. 2. 1 1/2" SANITARY VENT UP TO FLOOR ABOVE FROM FLOOR SINK/FLOOR DRAIN. SEE
- SHEET P2.6B FOR CONTINUATION. DROP TO FLOOR BELOW WITH SANITARY WASTE. SEE SHEET P2.4 FOR CONTINUATION.
- 4. RISE UP TO FLOOR ABOVE WITH 3" SEWAGE EJECTOR, VACUUM PUMP AND ORAL EVAC VENTS. SEE SHEET P2.6A FOR CONTINUATION.
- 3" PRIMARY STORM SEWER DOWN FROM FLOOR ABOVE AND CONTINUING DOWN TO FLOOR BELOW. SEE SHEETS P2.6B AND P2.4 FOR CONTINUATION.
- CONNECT TO EXISTING SANITARY WASTE ABOVE EXISTING EXAM ROOMS AT THIS LOCATION WITH NEW SANITARY WASTE PIPING. COORDINATE NEW ROUTING AND CONNECTION WITH EXISTING CONDITIONS.
- SANITARY VENT UP FROM FLOOR BELOW AND CONTINUING TO FLOOR ABOVE. SEE SHEETS P2.4 AND P2.6B FOR CONTINUATION.
- 8. CAP VENT 2 INCHES BELOW STRUCTURE FOR FUTURE CONNECTION.
- 9. 2" SANITARY WASTE DOWN FROM FLOOR SINK ABOVE. SEE SHEET P2.6B FOR
- 10. 2 1/2" DECONTAMINATION TANK VENT UP FROM FLOOR BELOW AND CONTINUING UP TO FLOOR ABOVE. SEE SHEETS P2.4 AND P2.6B FOR CONTINUATION.
- 11. 2" WASTE DOWN FROM FLOOR DRAIN ABOVE. SEE SHEET P2.6B FOR CONTINUATION. 12. 2 1/2" SANITARY VENT UP TO FLOOR ABOVE. SEE SHEET P2.6B FOR CONTINUATION.
- 13. 4" SANITARY WASTE STACK DOWN FROM FLOOR ABOVE. SEE SHEET P2.6B FOR
- 14. 2" SANITARY VENT UP TO FLOOR ABOVE FROM SERVICE SINK. SEE SHEET P2.6B FOR
- 5. 2" SANITARY WASTE DOWN FROM SURGICAL SCRUB SINK. SEE SHEET P2.6B FOR
- 16. 2" SANITARY WASTE DOWN FROM VERNA CARE EQUIPMENT. SEE SHEET P2.6B FOR
- 17. 3" SANITARY WASTE DOWN FROM SERVICE SINK. SEE SHEET P2.6B FOR CONTINUATION. 18. CONNECT TO EXISTING 2" VENT WITH NEW AT THIS LOCATION AND EXTEND AS SHOWN.
- COORDINATE NEW ROUTING WITH EXISTING CONDITIONS. 19. 3" SANITARY WASTE DOWN FOR FUTURE STERILIZER EQUIPMENT. SEE SHEET P2.6B FOR
- 20. 2" SANITARY VENT UP TO FLOOR ABOVE FOR FUTURE STERILIZER EQUIPMENT. SEE SHEET
- 21. INSTALL CLEAN-OUT AT BASE OF STACK 6" ABOVE FINISHED FLOOR.
- 22. 3" SANITARY WASTE DOWN FROM FLOOR ABOVE. SEE SHEET P2.6B FOR CONTINUATION.

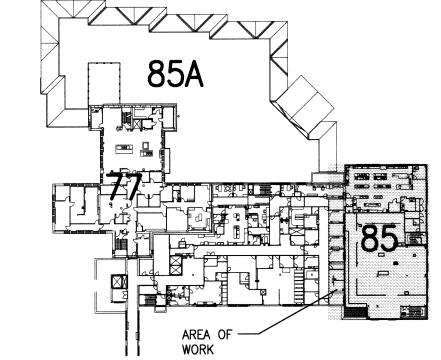

FOR CONSTRUCTION








531-317 DRAWING NO.


DWG 139 OF 188

VAMC BOISE, IDAHO

APPROVED: MEDICAL CENTER DIRECTOR

DEPARTMENT OF VETERANS AFFAIRS

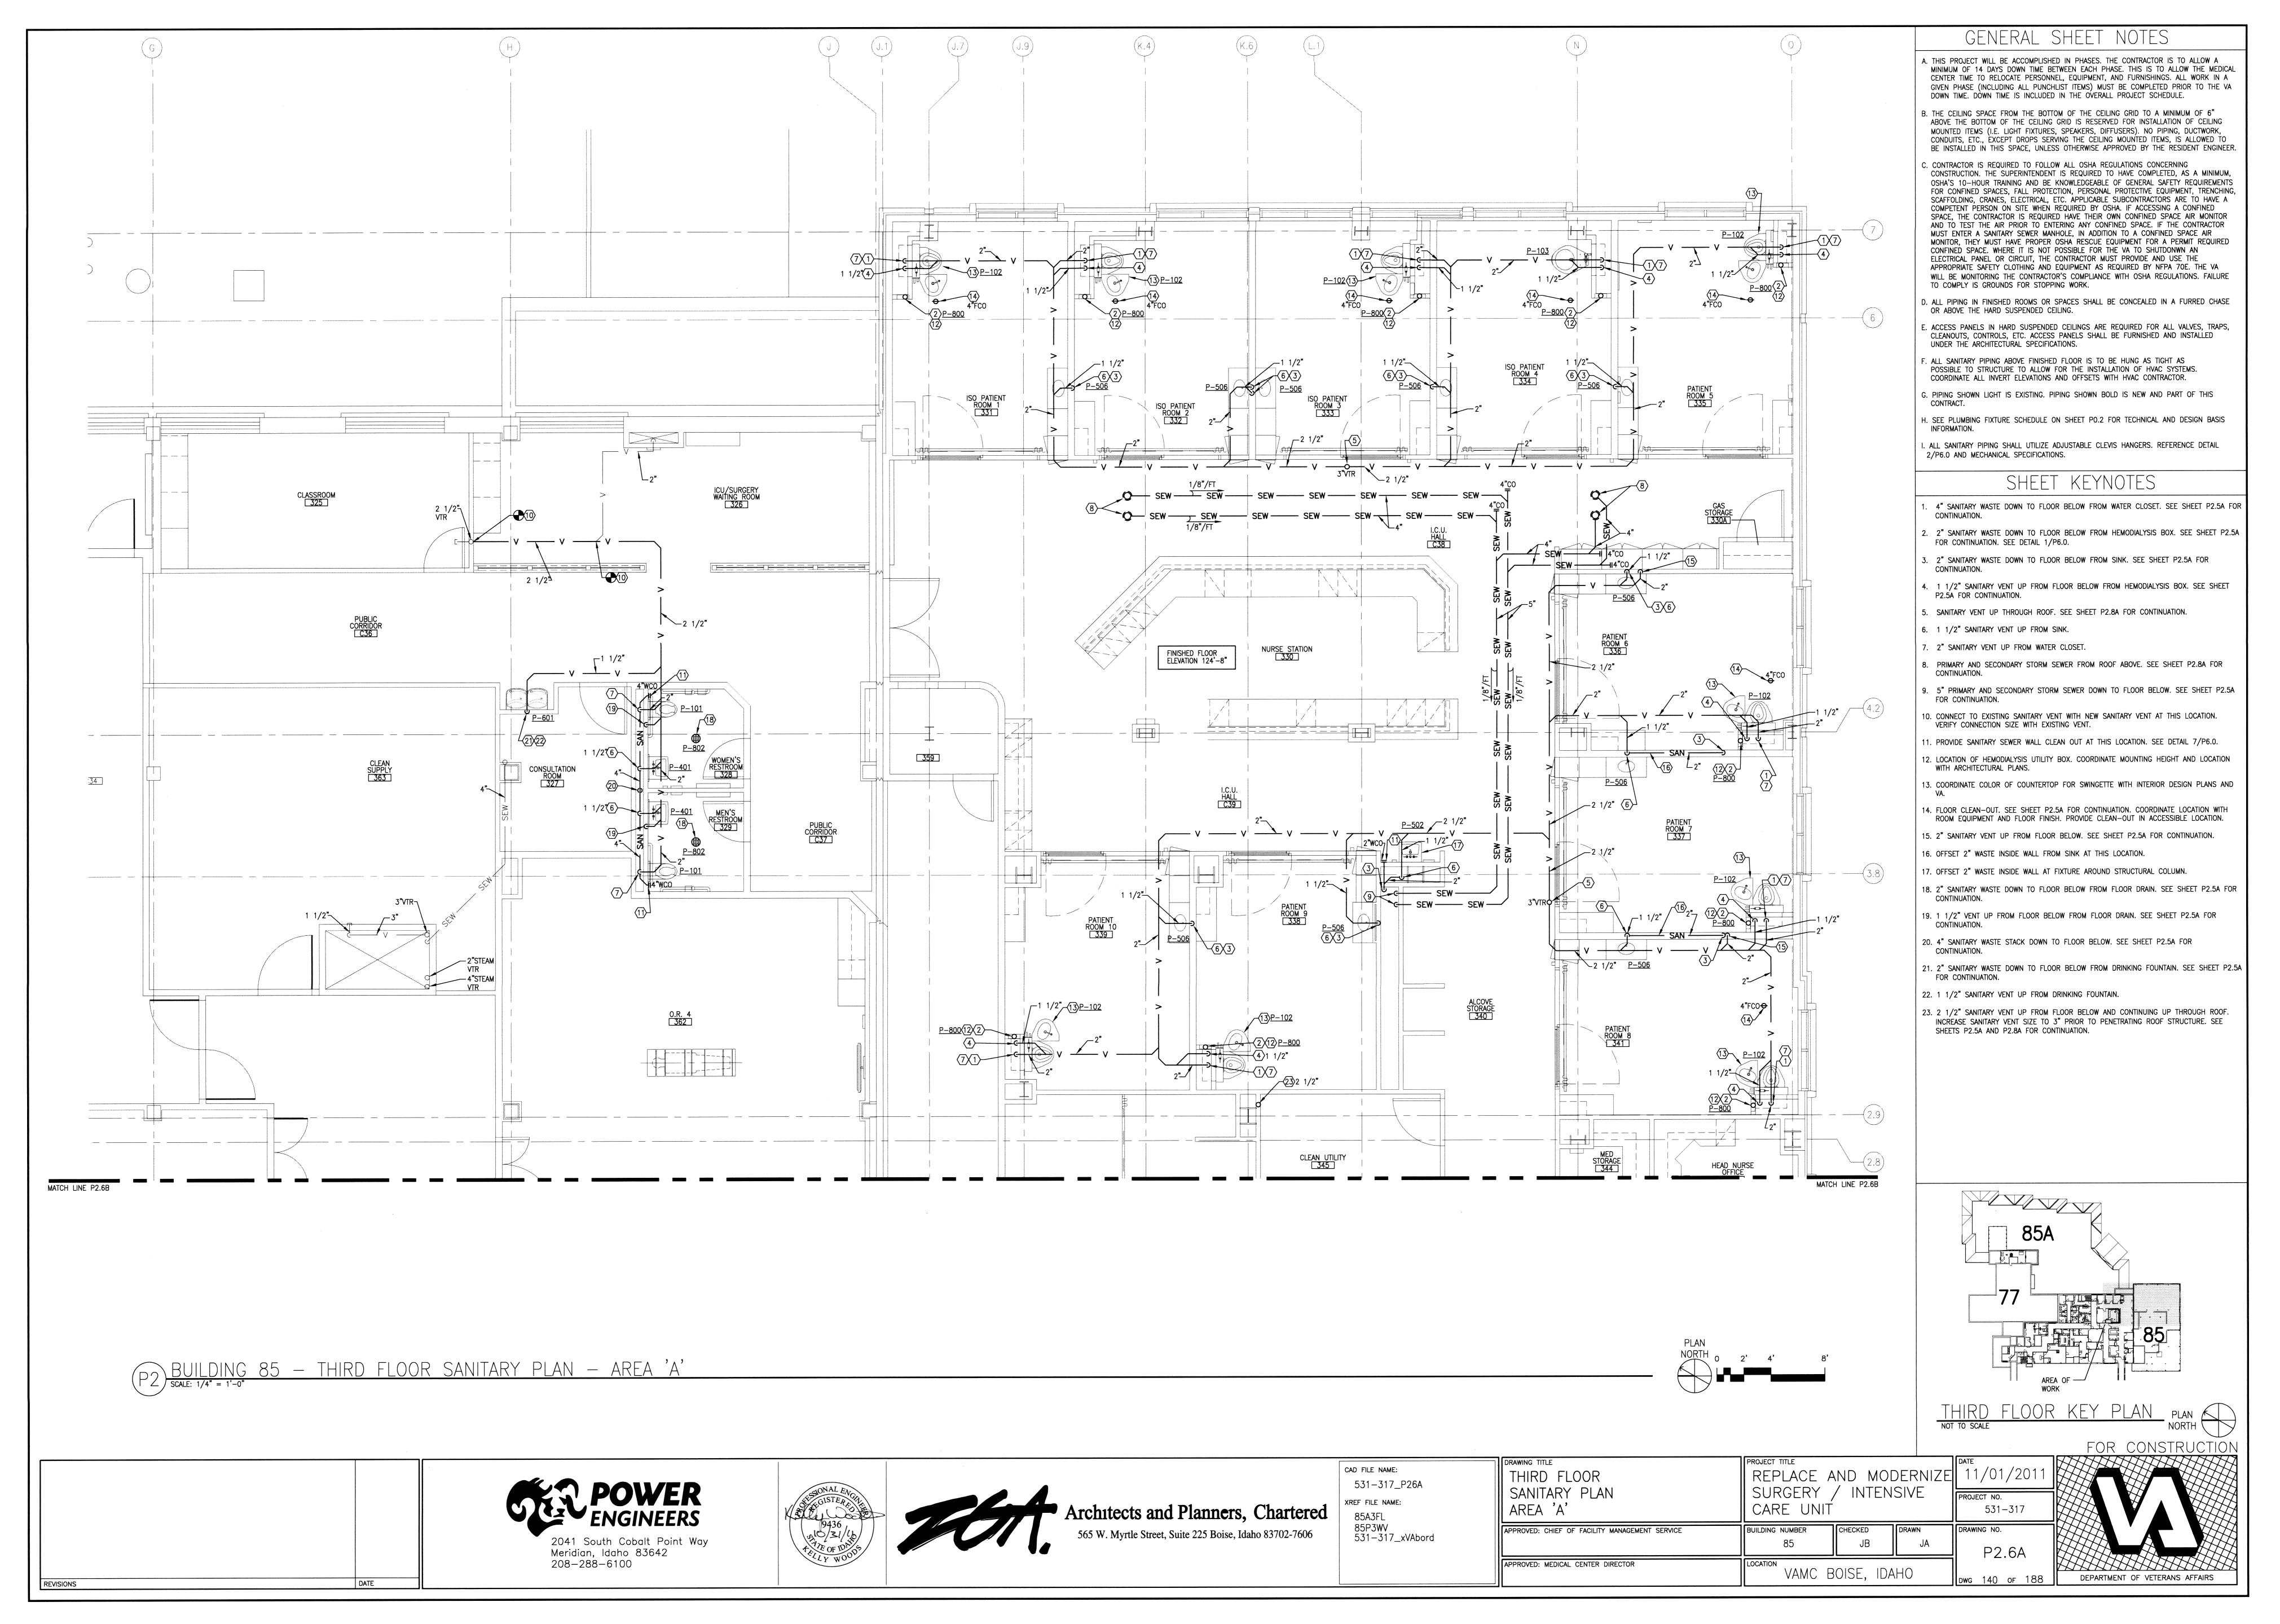


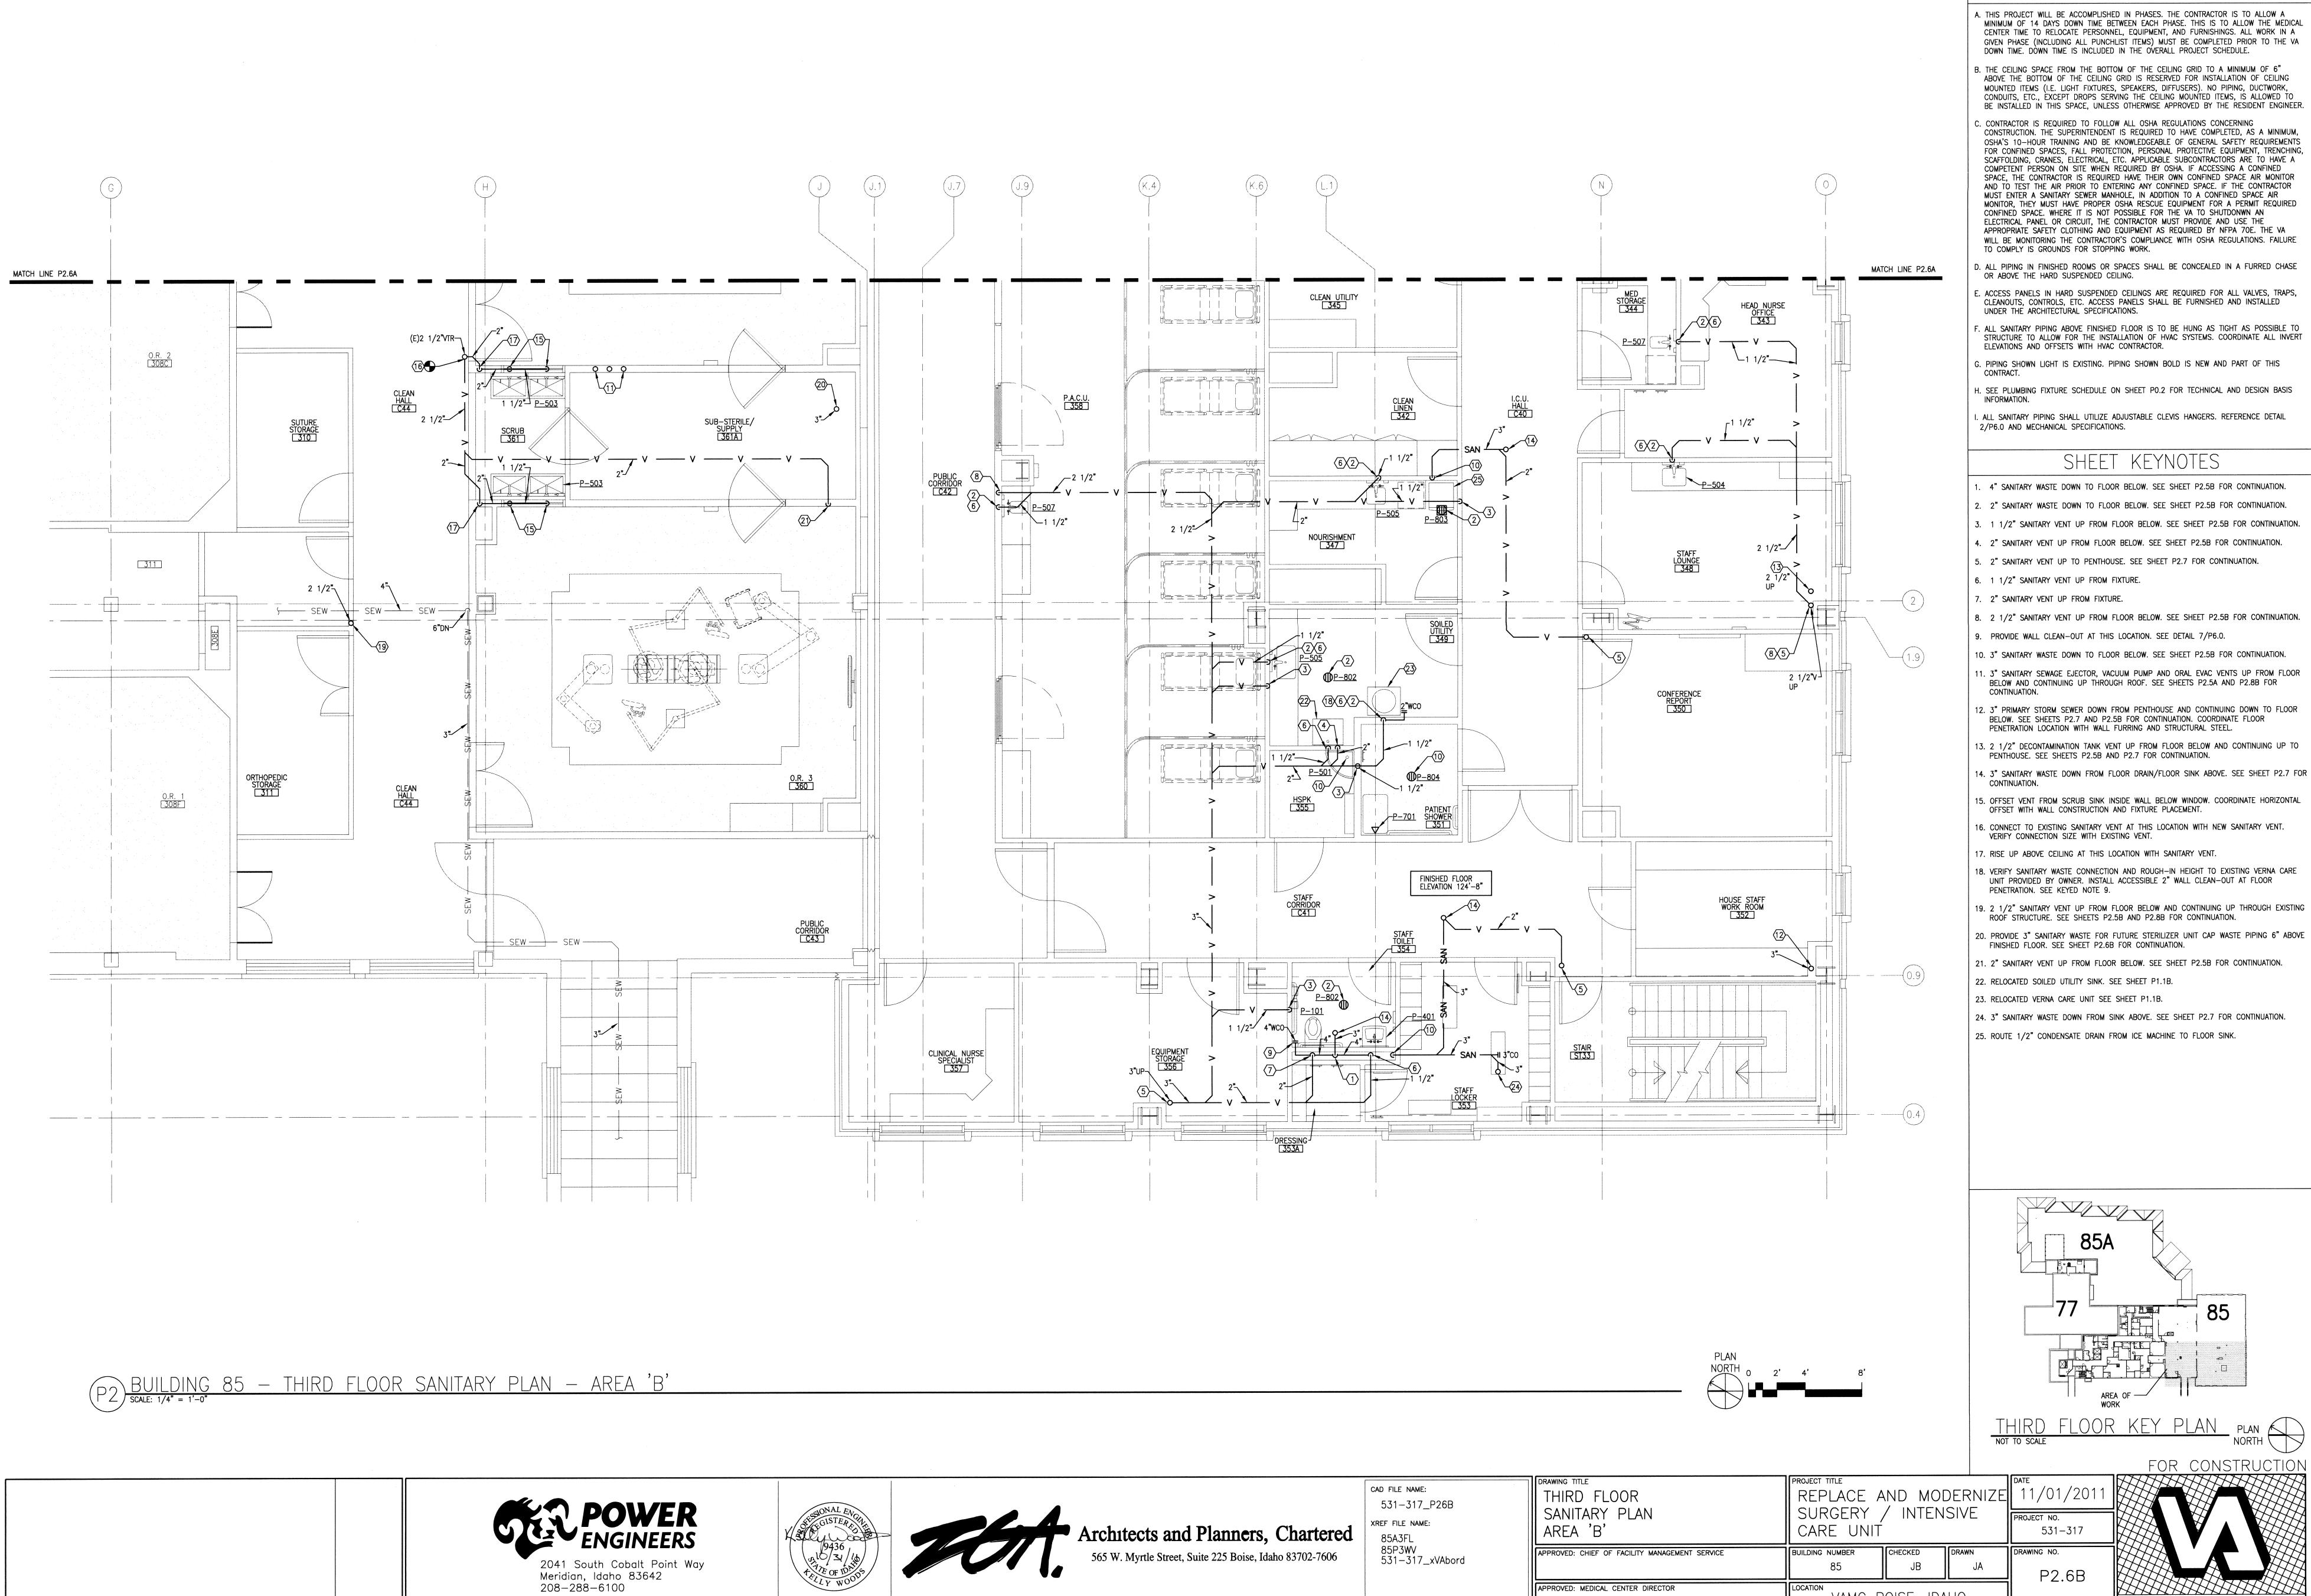



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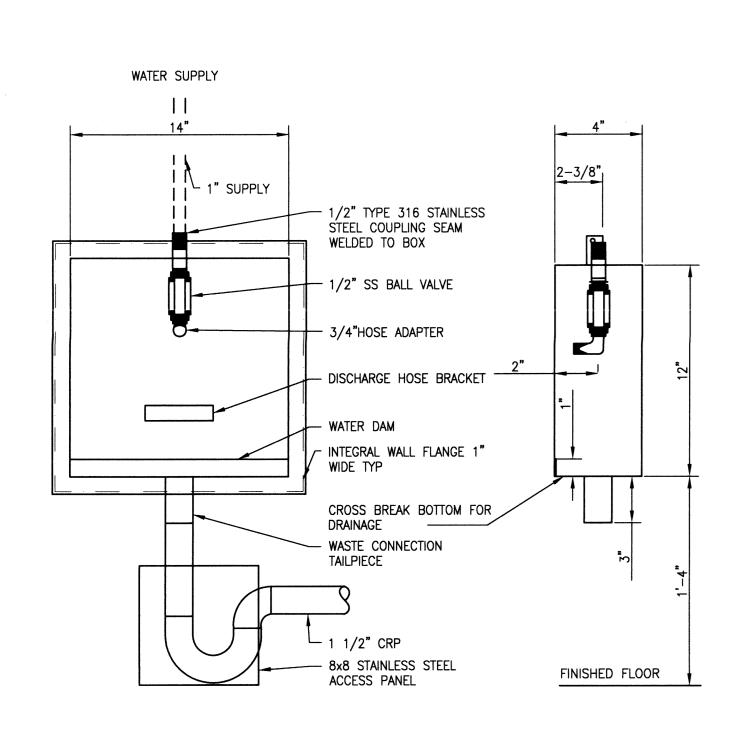
VAMC BOISE, IDAHO

GENERAL SHEET




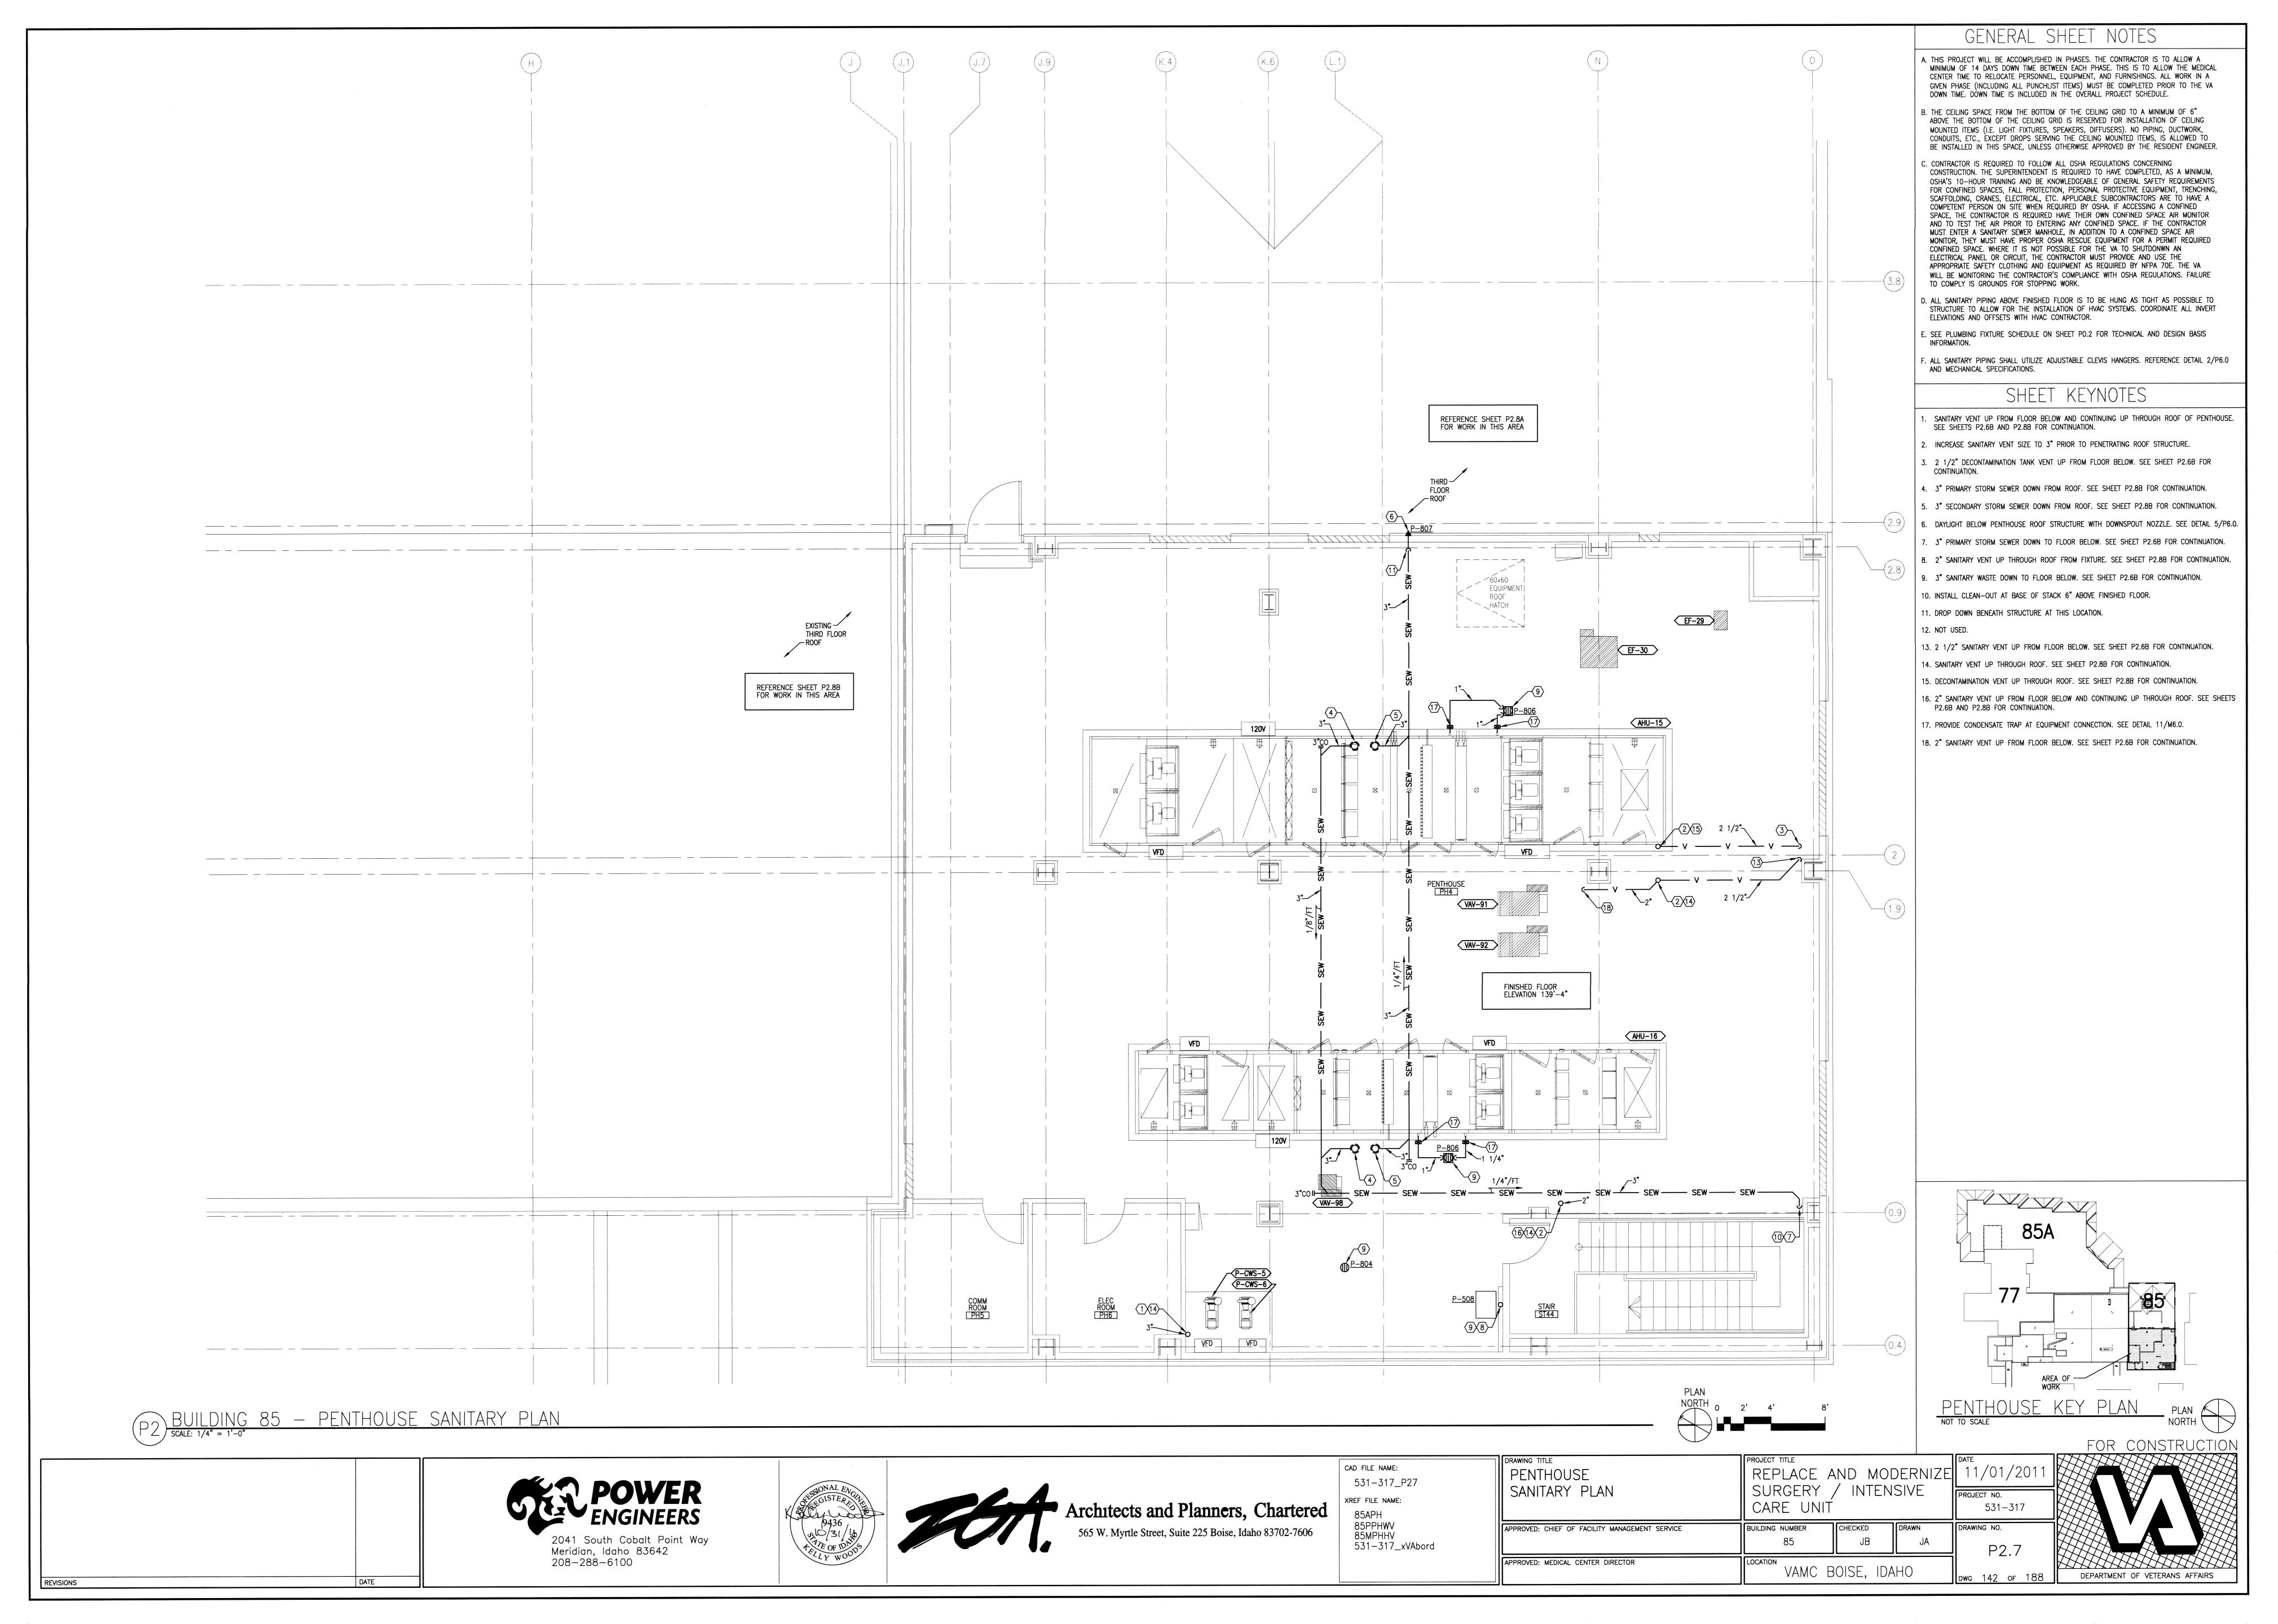

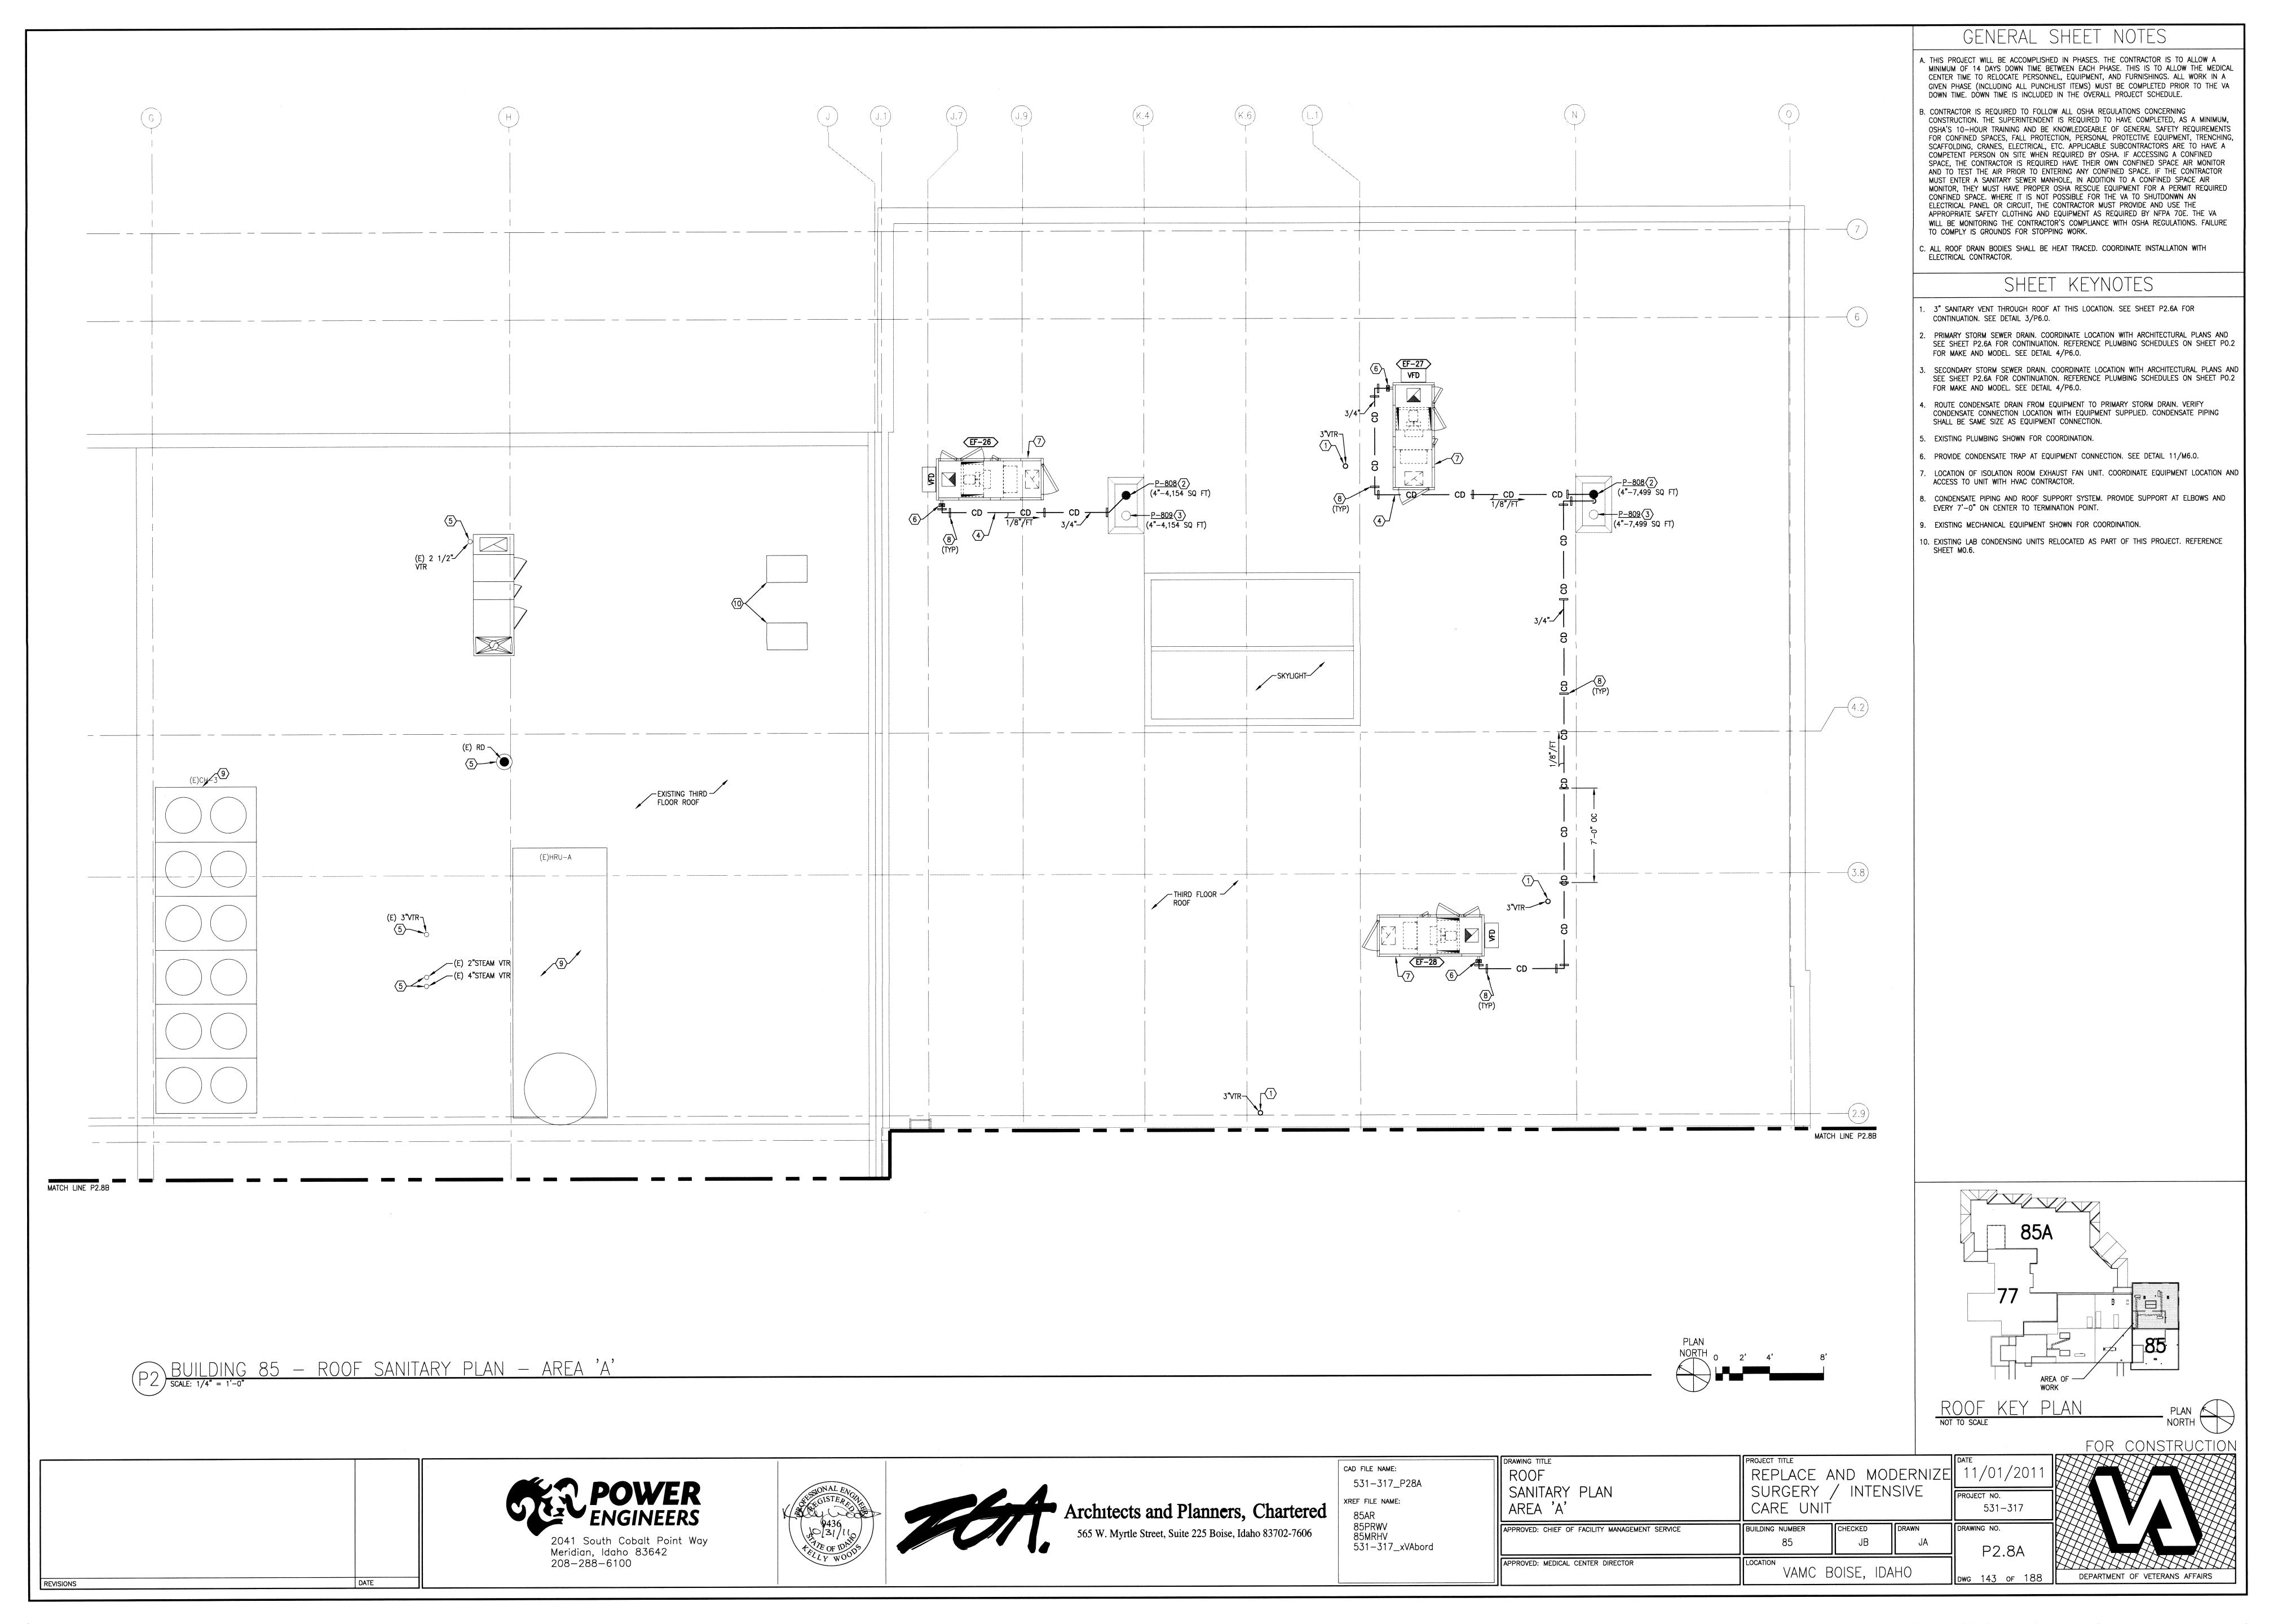


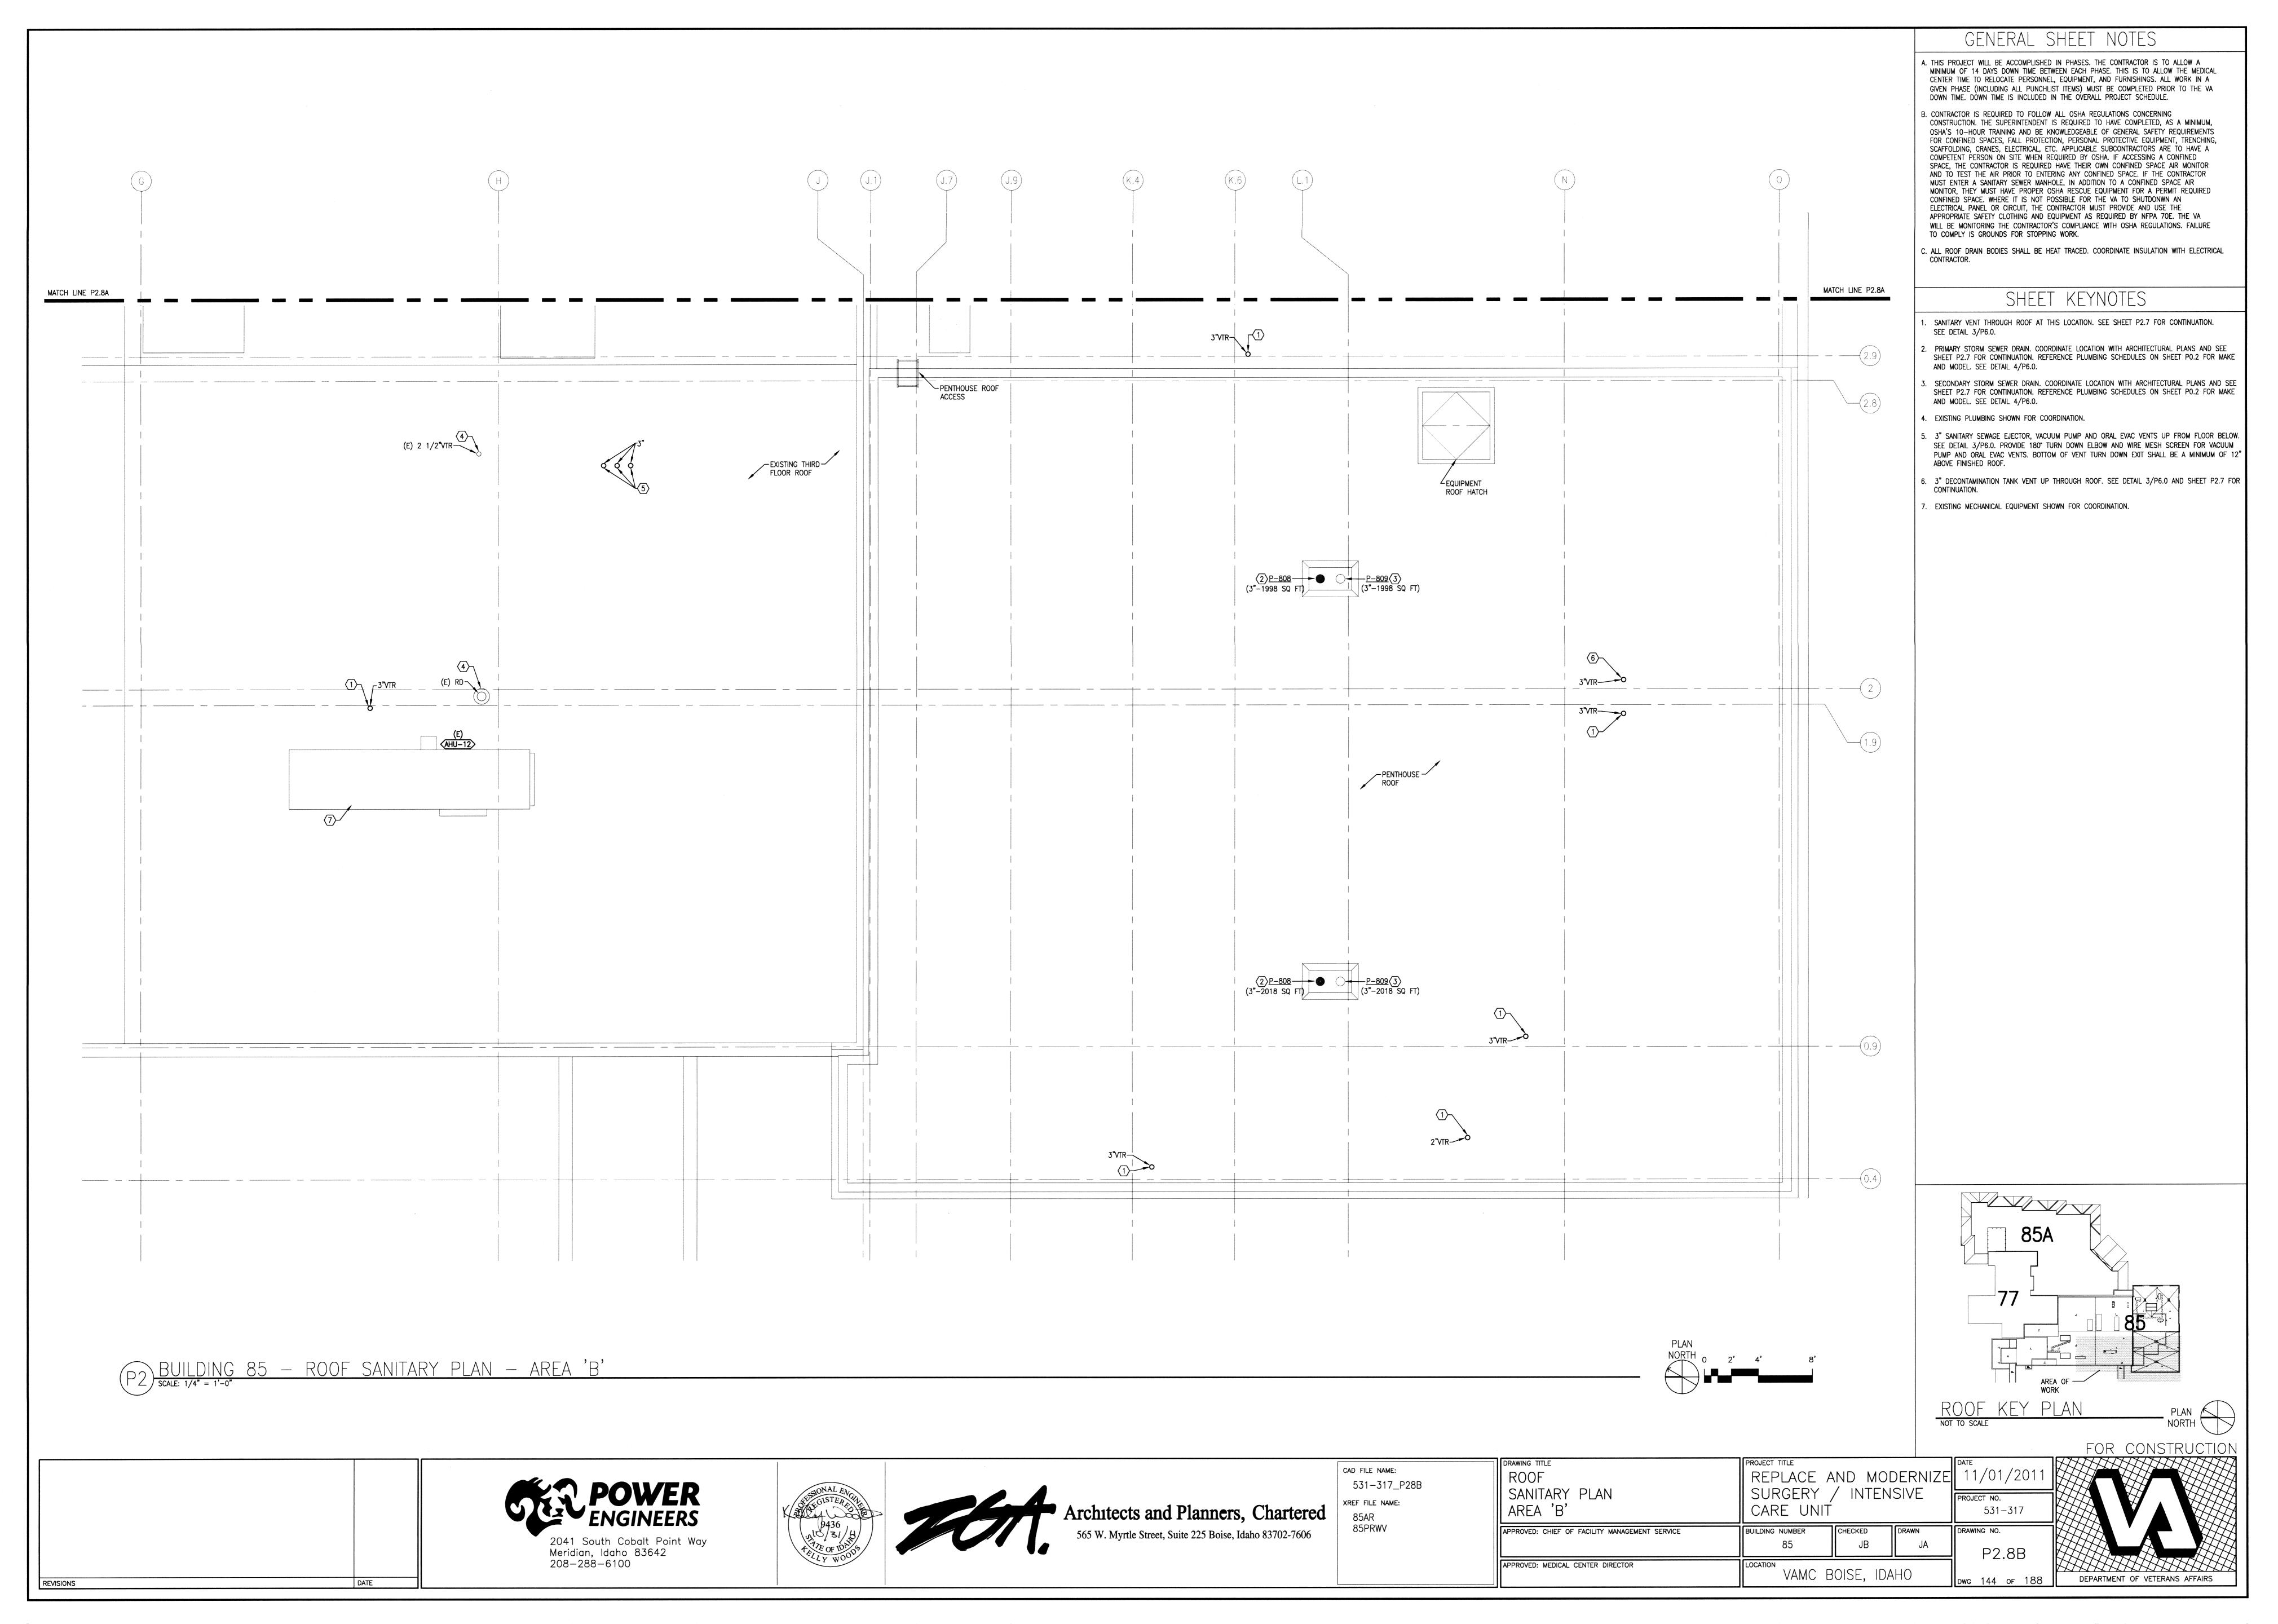




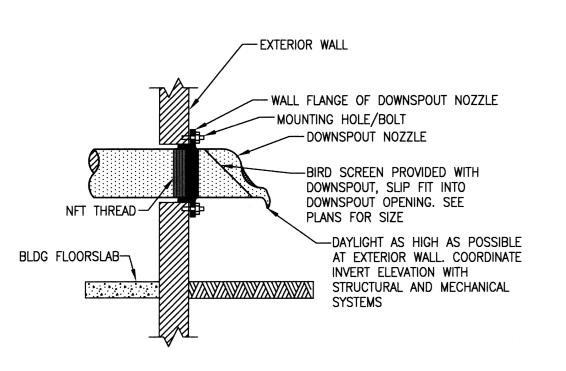



5 DOWNSPOUT NOZZLE DETAIL

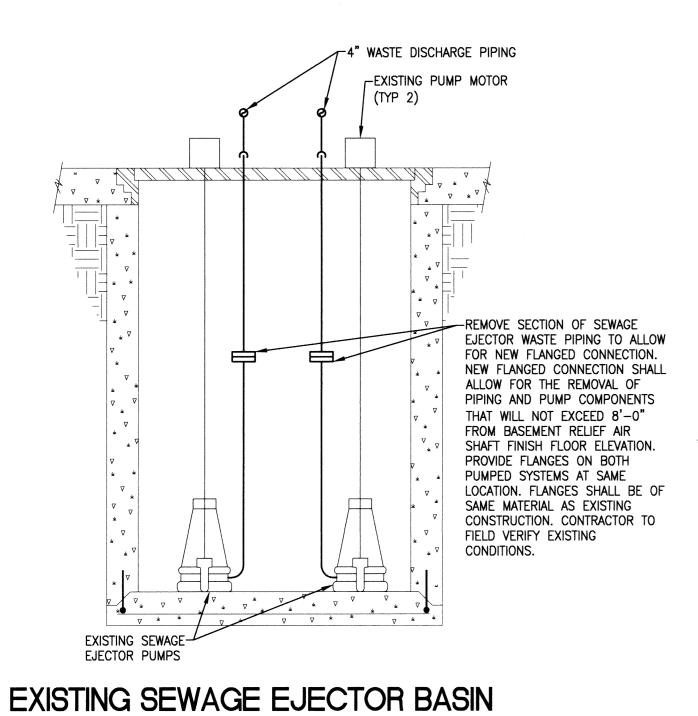


PIPING LIFT DEMOLITION / REMODEL DETAIL

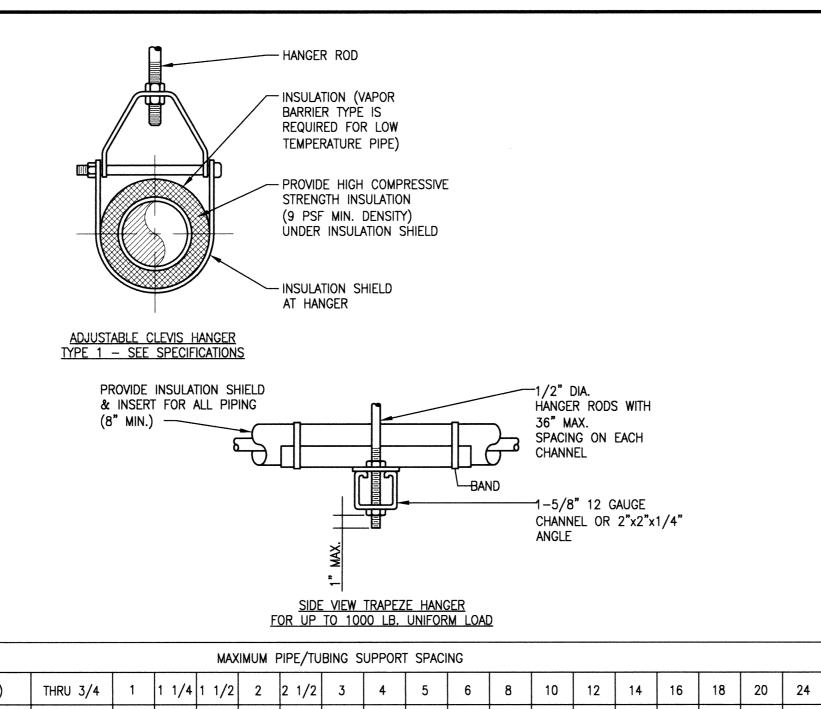

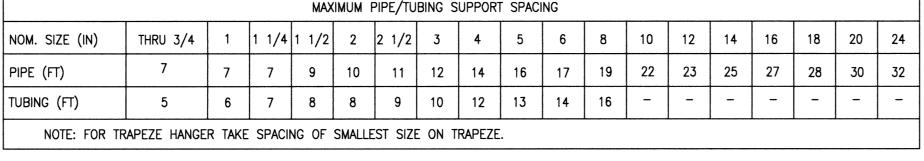


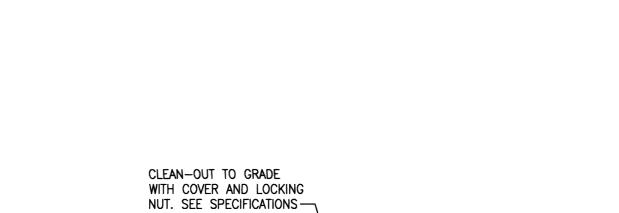


PIPE HANGERS

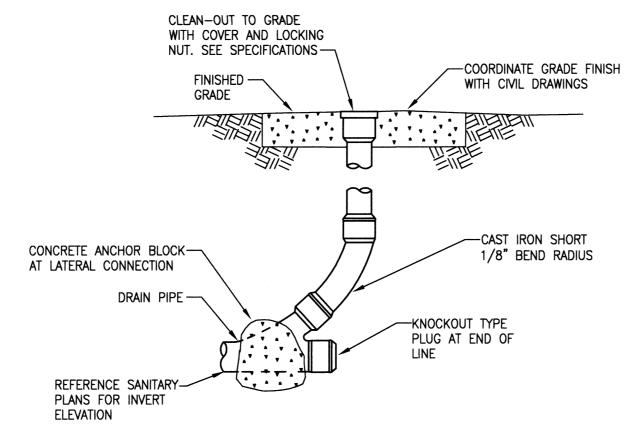


CLEANOUT TO GRADE DETAIL

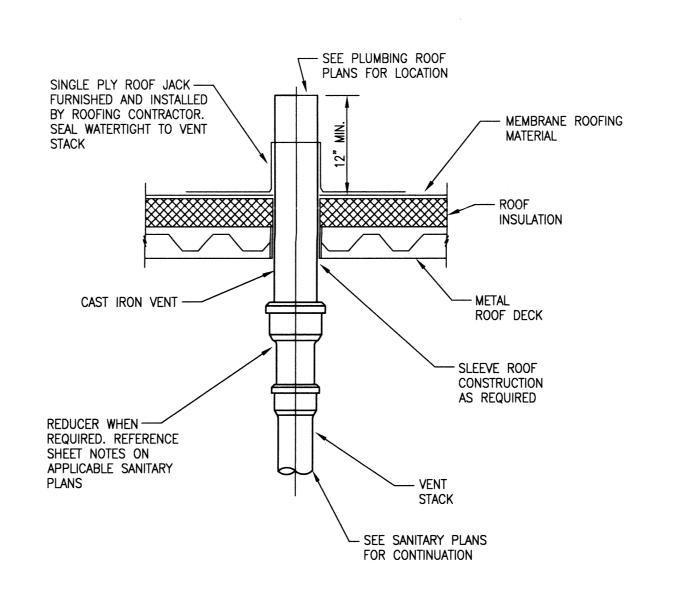




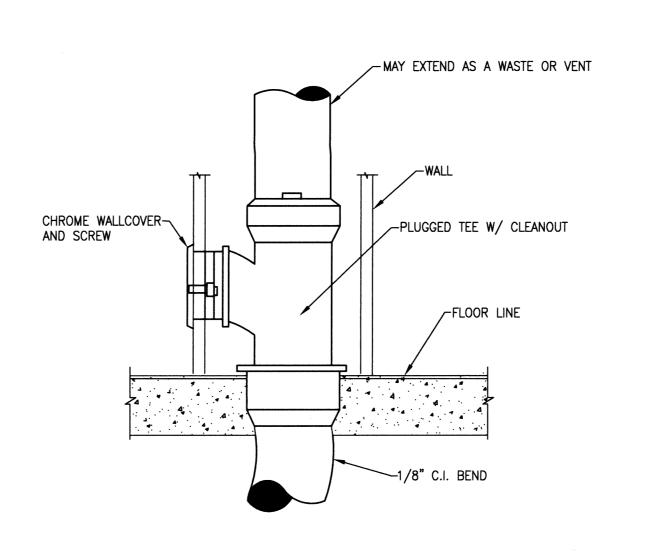

WALL CLEANOUT DETAIL

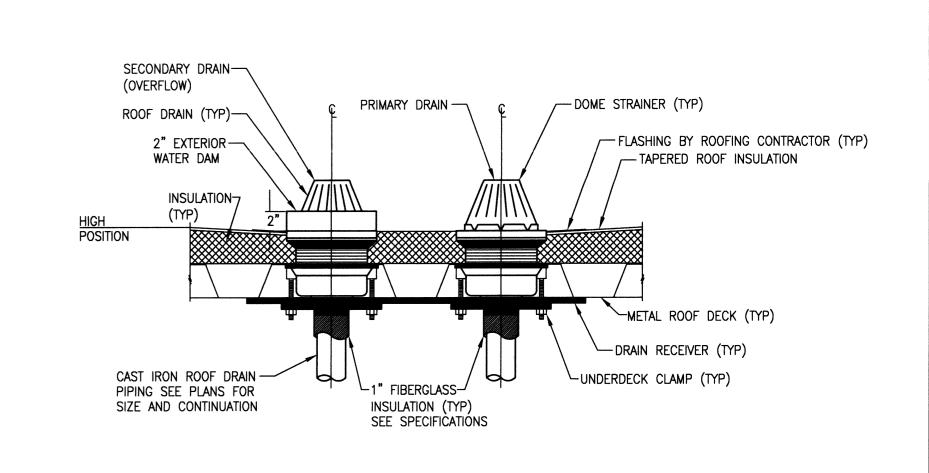


ROOF AND OVERFLOW DRAIN DETAIL

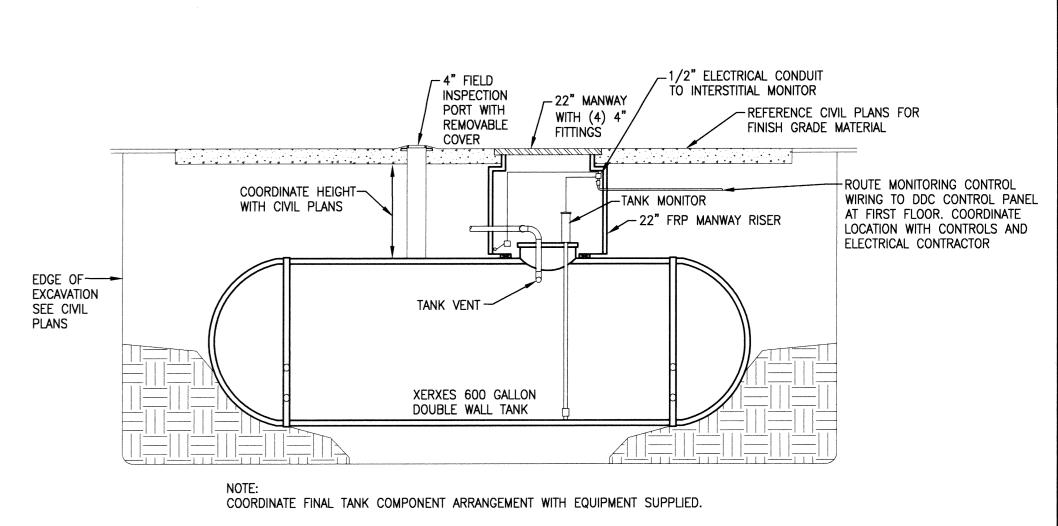

DECONTAMINATION STORAGE TANK DETAIL



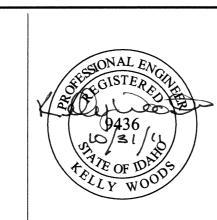




CAD FILE NAME: 531-317_P60 531-317_xVAbord

PROJECT TITLE	NID	\\	DATE 1 1
11			
SURGERY / INTENSIVE PRO			PROJE
BUILDING NUMBER	CHECKED	DRAWN	DRAWII
85	JB	JA	
	REPLACE A SURGERY , CARE UNIT	REPLACE AND MODE SURGERY / INTEN CARE UNIT	REPLACE AND MODERNIZE SURGERY / INTENSIVE CARE UNIT BUILDING NUMBER CHECKED DRAWN

FOR CONSTRUCTION DEPARTMENT OF VETERANS AFFAIRS

APPROVED: MEDICAL CENTER DIRECTOR

P6.0 VAMC BOISE, IDAHO

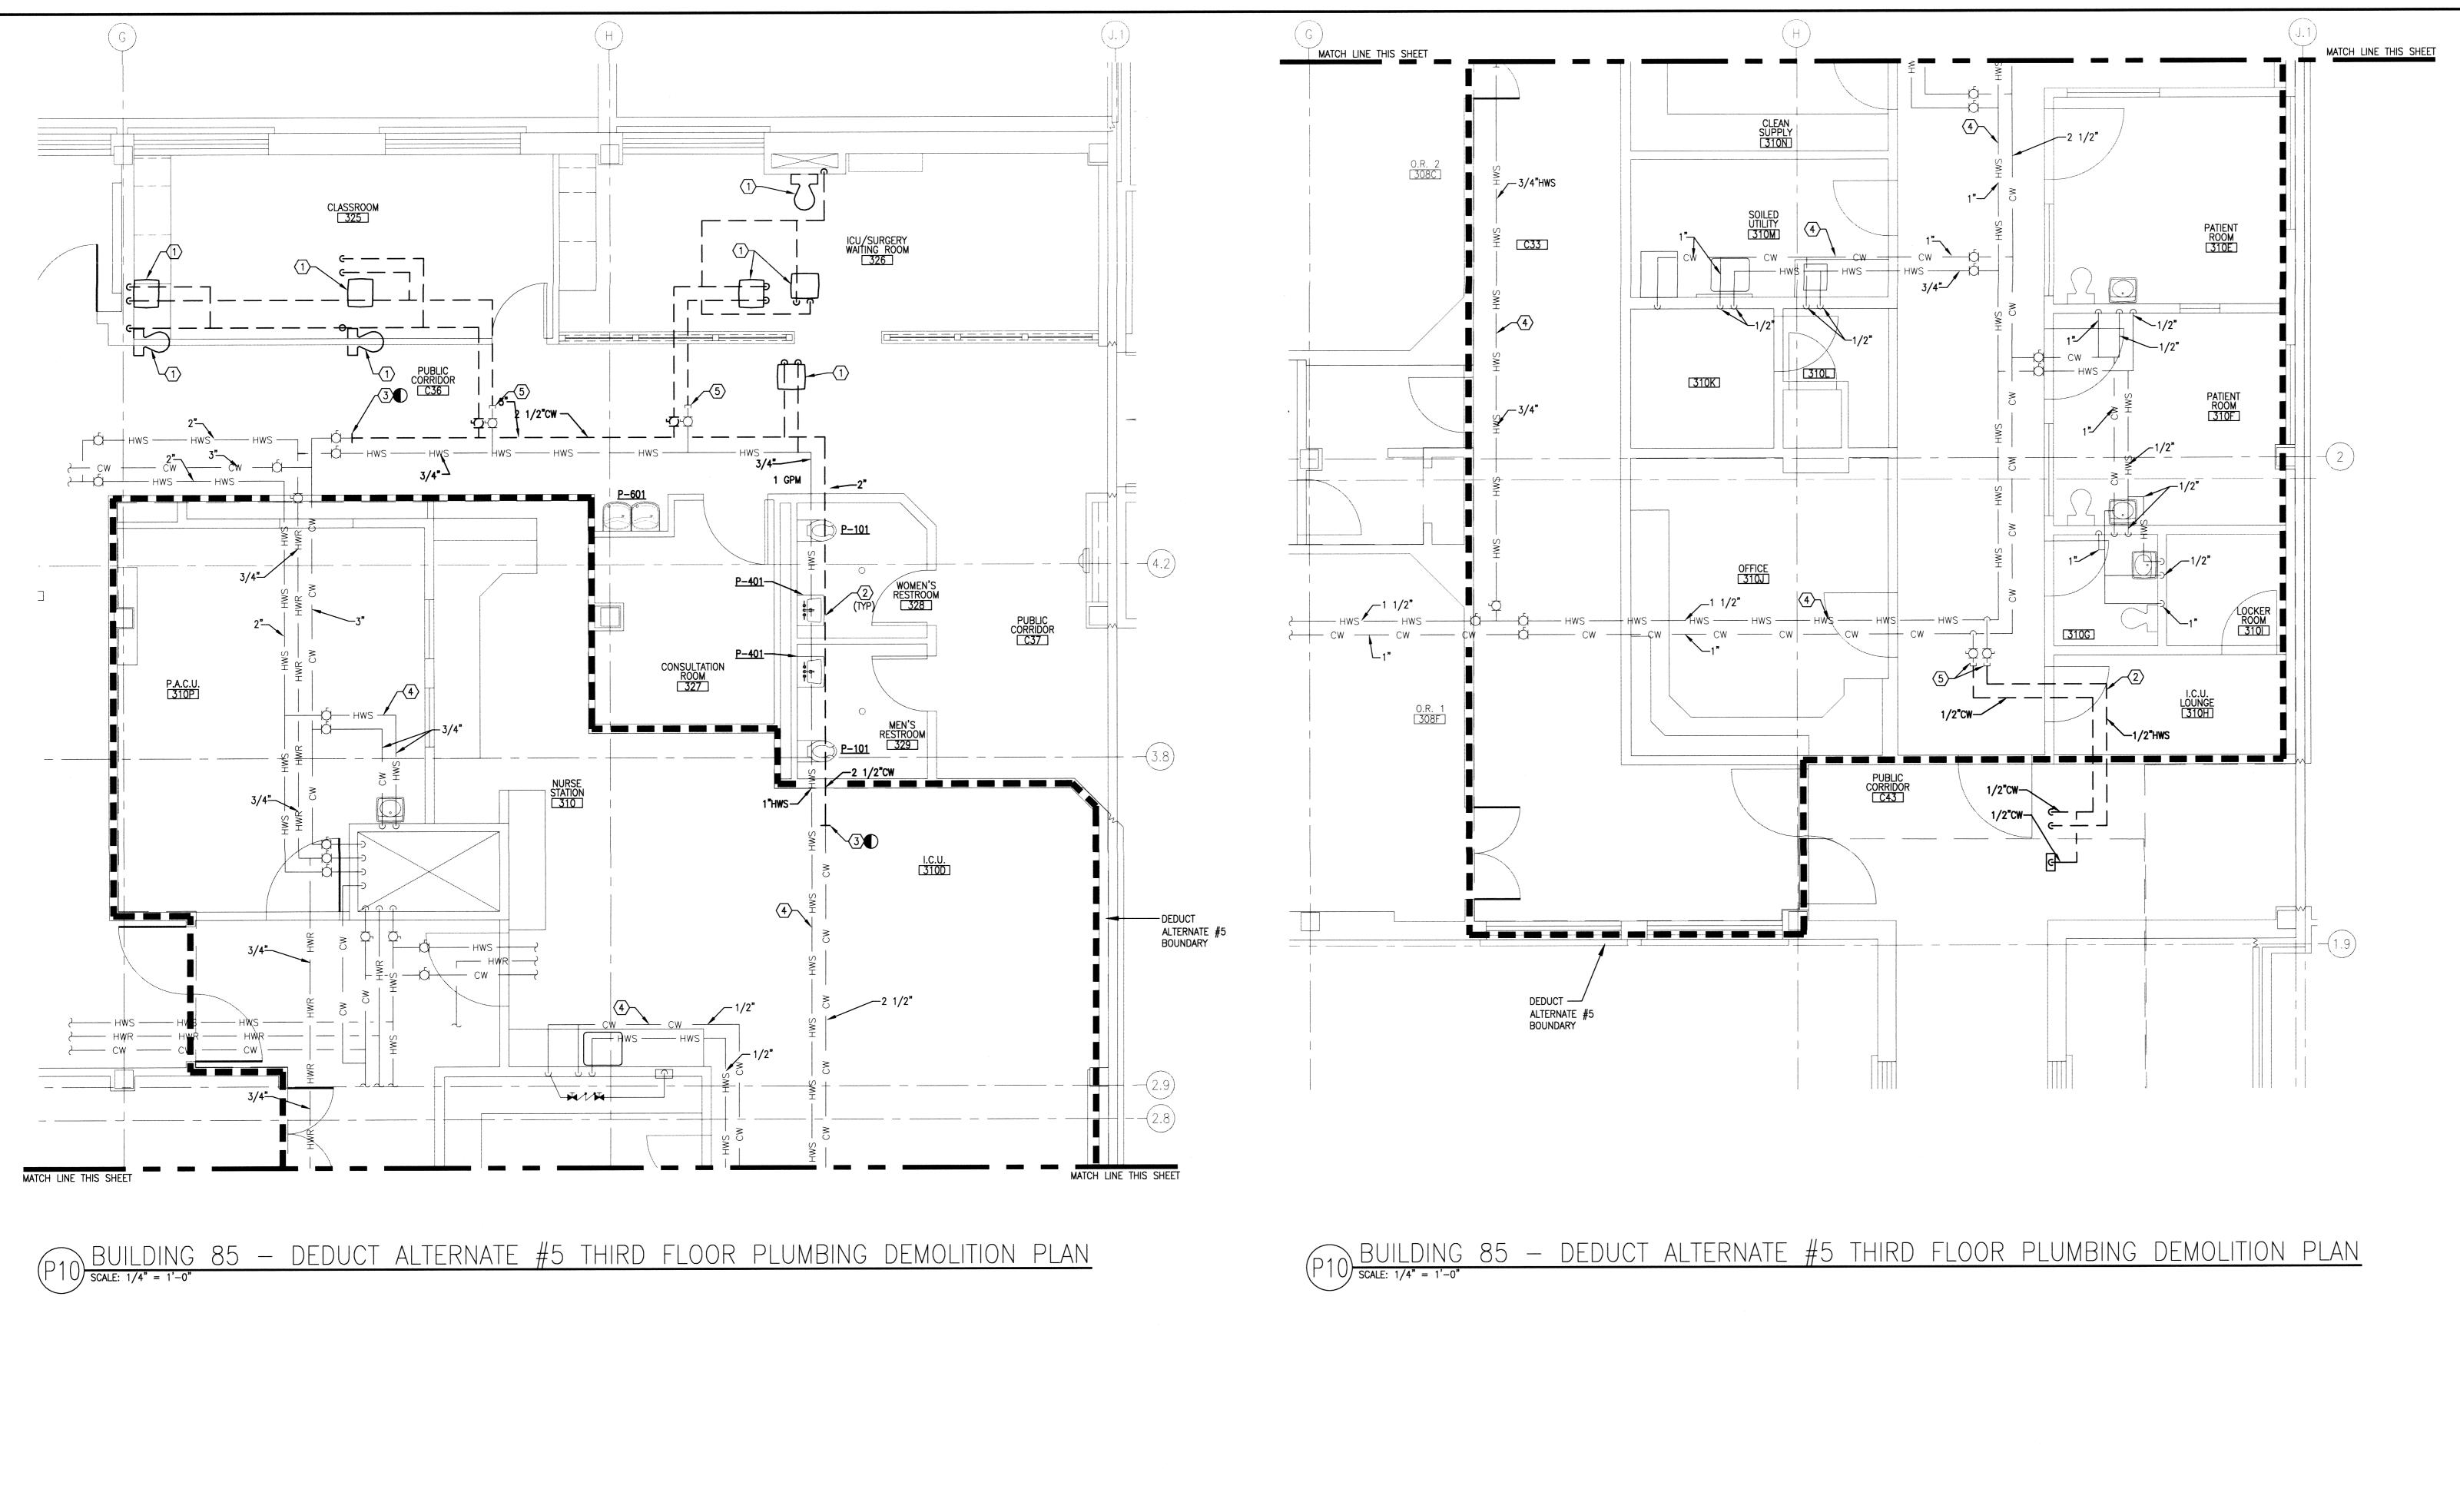

DEDUCT ALTERNATE #5 PLUMBING DEMOLITION NARRATIVE

A. REMOVE PLUMBING FIXTURES AND ASSOCIATED PIPING AND VALVES SERVING EXISTING PATIENT ROOMS 310A, 310B, AND 310C. REMOVE AND CAP PLUMBING SERVING EXISTING ICU LOUNGE 310H EQUIPMENT. SEE PLUMBING DEMOLITION PLANS ON SHEETS P1.1A AND P1.1B FOR EXISTING ARCHITECTURAL BACKGROUND INFORMATION.


SHEET KEYNOTES


. REMOVE EXISTING PLUMBING FIXTURE AND ASSOCIATED ROUGH-IN PLUMBING. 2. REMOVE PLUMBING SHOWN BOLD AND DASHED ALONG WITH ASSOCIATED VALVES, STOPS

AND INSULATION. 3. REMOVE EXISTING PLUMBING BACK TO THIS POINT. SEE SHEET P10.1B FOR NEW WORK.

4. EXISTING PLUMBING SHOWN LIGHT IS TO REMAIN.


5. CAP EXISTING PLUMBING.

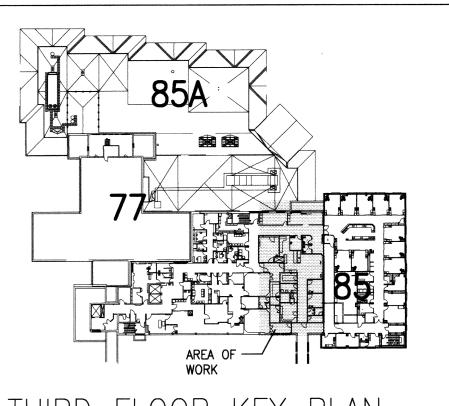

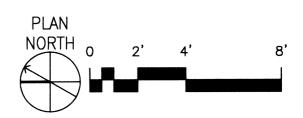

FOR CONSTRUCTION

2041 South Cobalt Point Way Meridian, Idaho 83642 208-288-6100

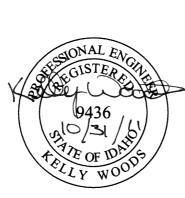



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CAD FILE NAME:
531-317_P101A
(REF FILE NAME:
85A3FL_ALT 85M3WA_ALT 531-317_xVAbord

APPROVED: MEDICAL CENTER DIRECTOR

DEDUCT ALTERNATE #5
THIRD FLOOR REPLACE AND MODERNIZE SURGERY / / INTENSIVE PLUMBING DEMOLITION PLAN APPROVED: CHIEF OF FACILITY MANAGEMENT SERVICE

BUILDING NUMBER

VAMC BOISE, IDAHO


11/01/201 531-317


DWG 146 OF 188


DEPARTMENT OF VETERANS AFFAIRS


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REVISIONS




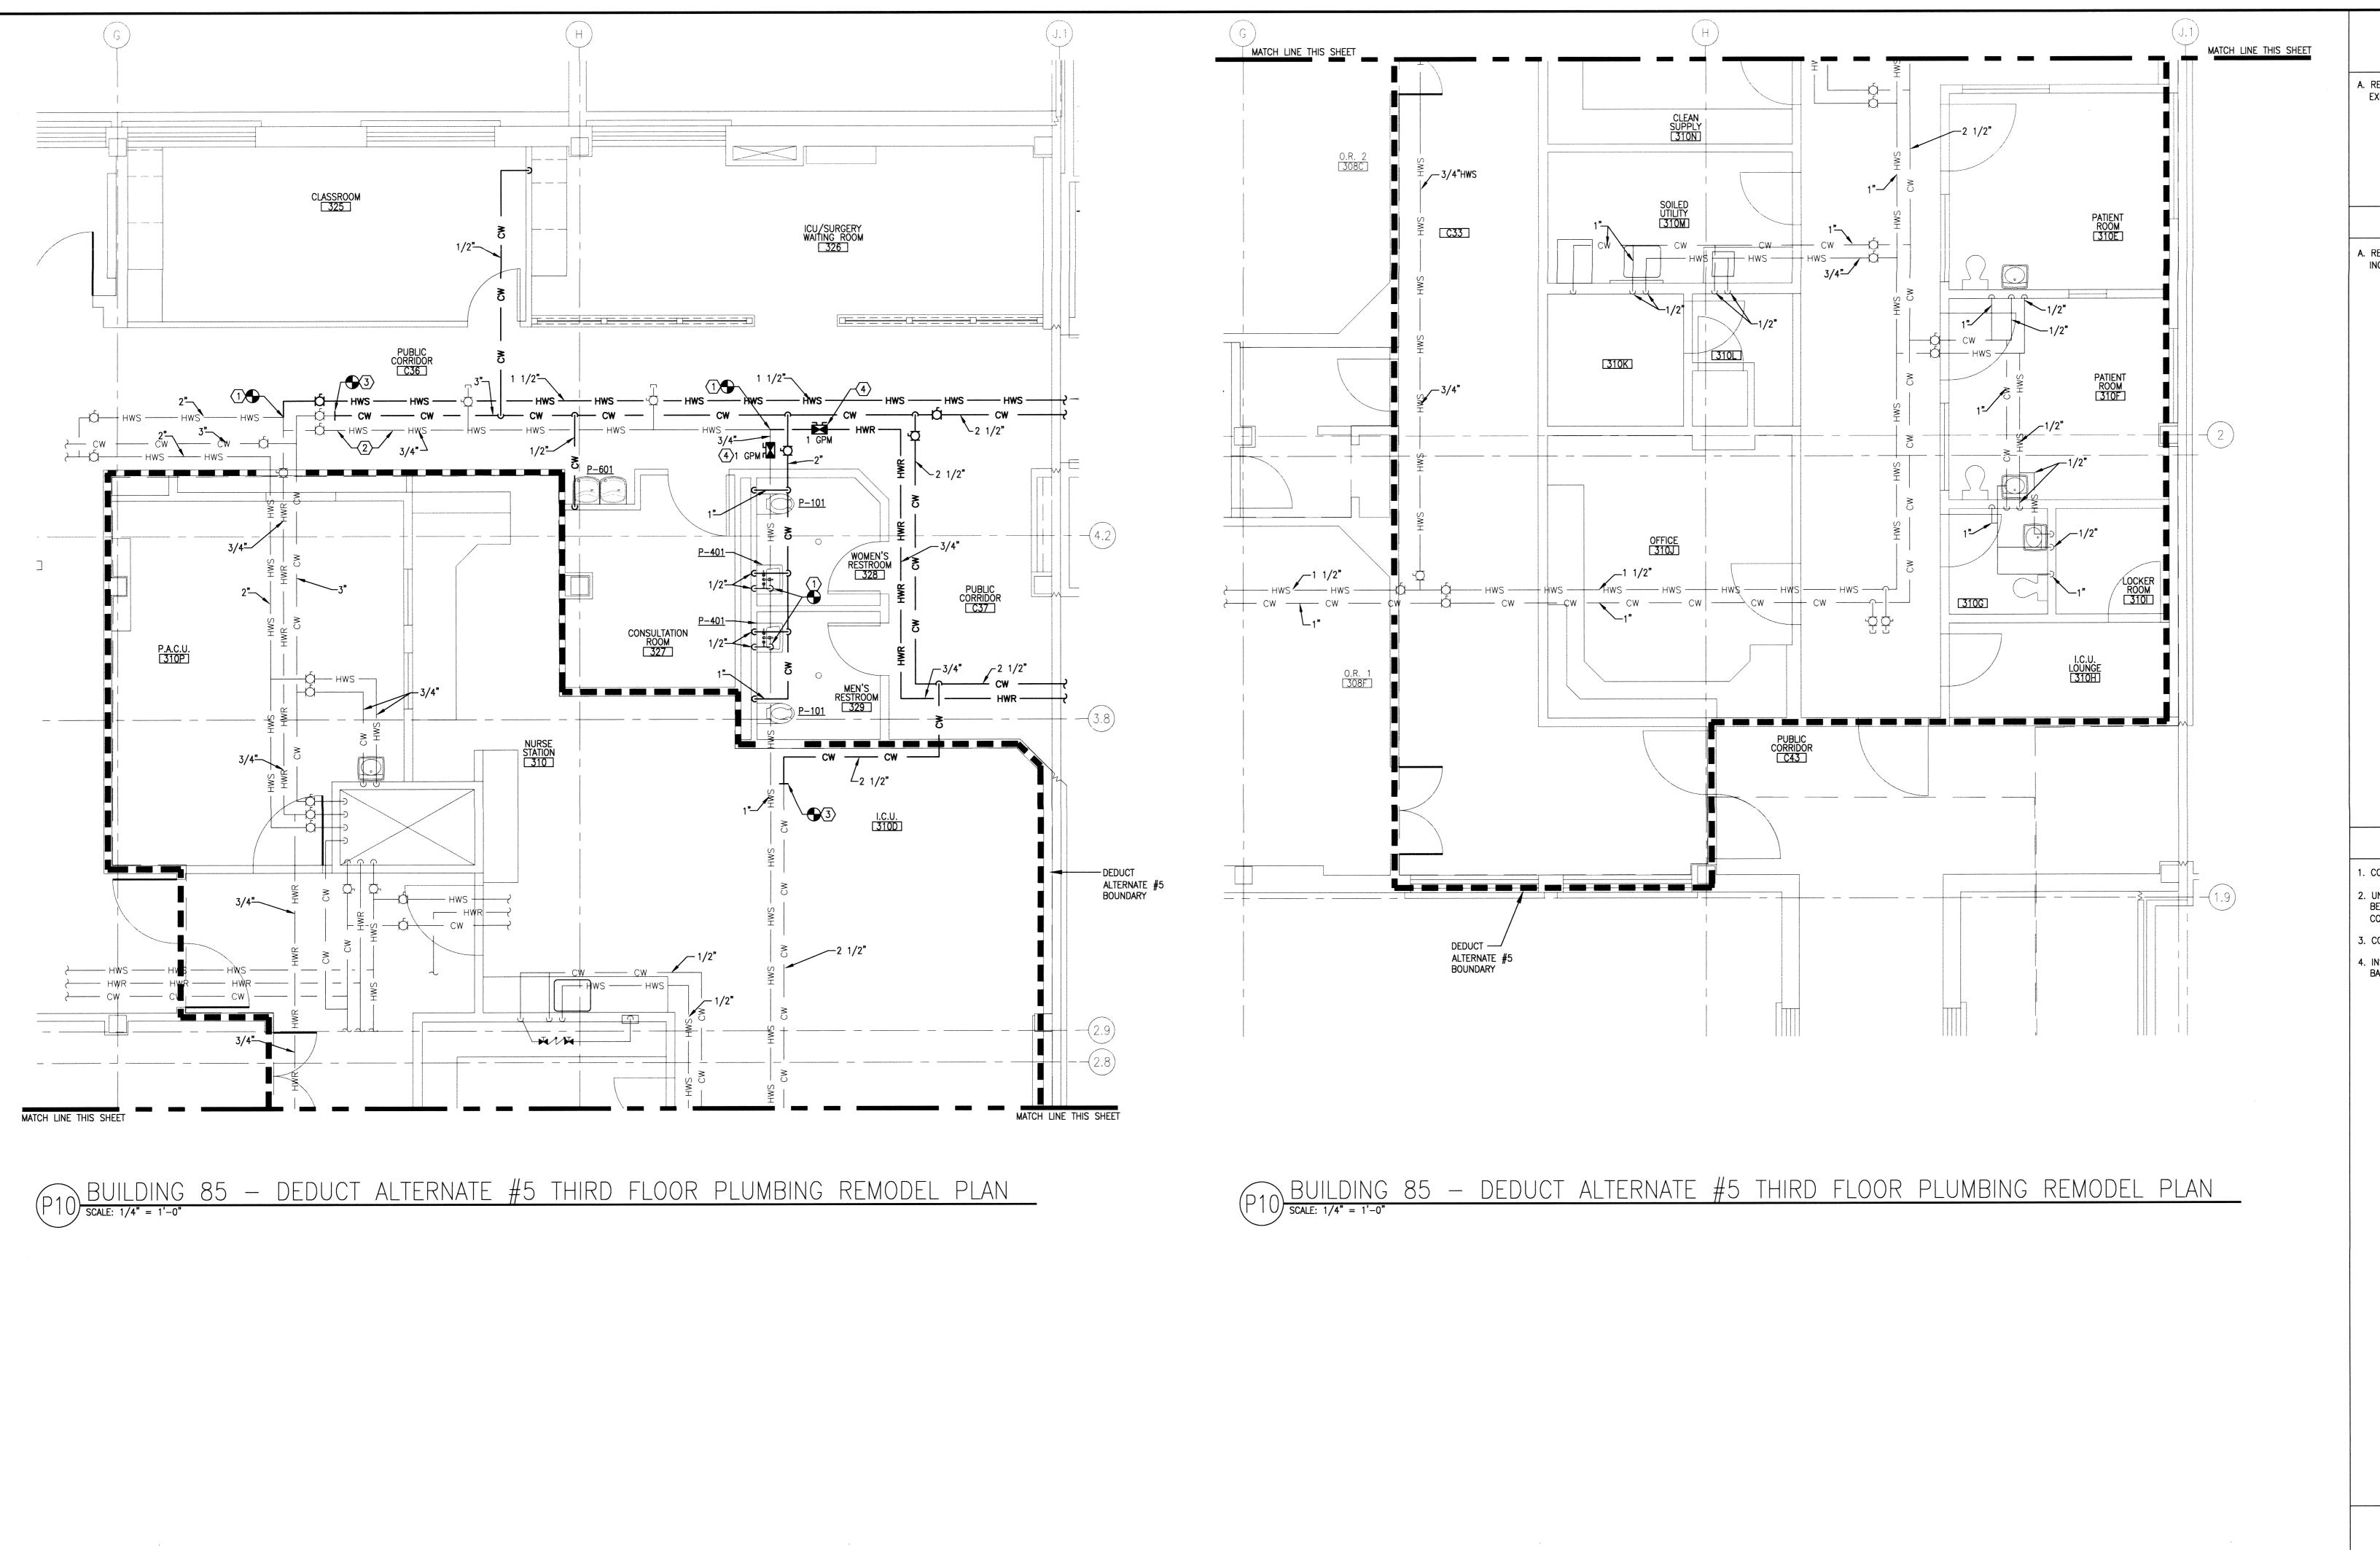

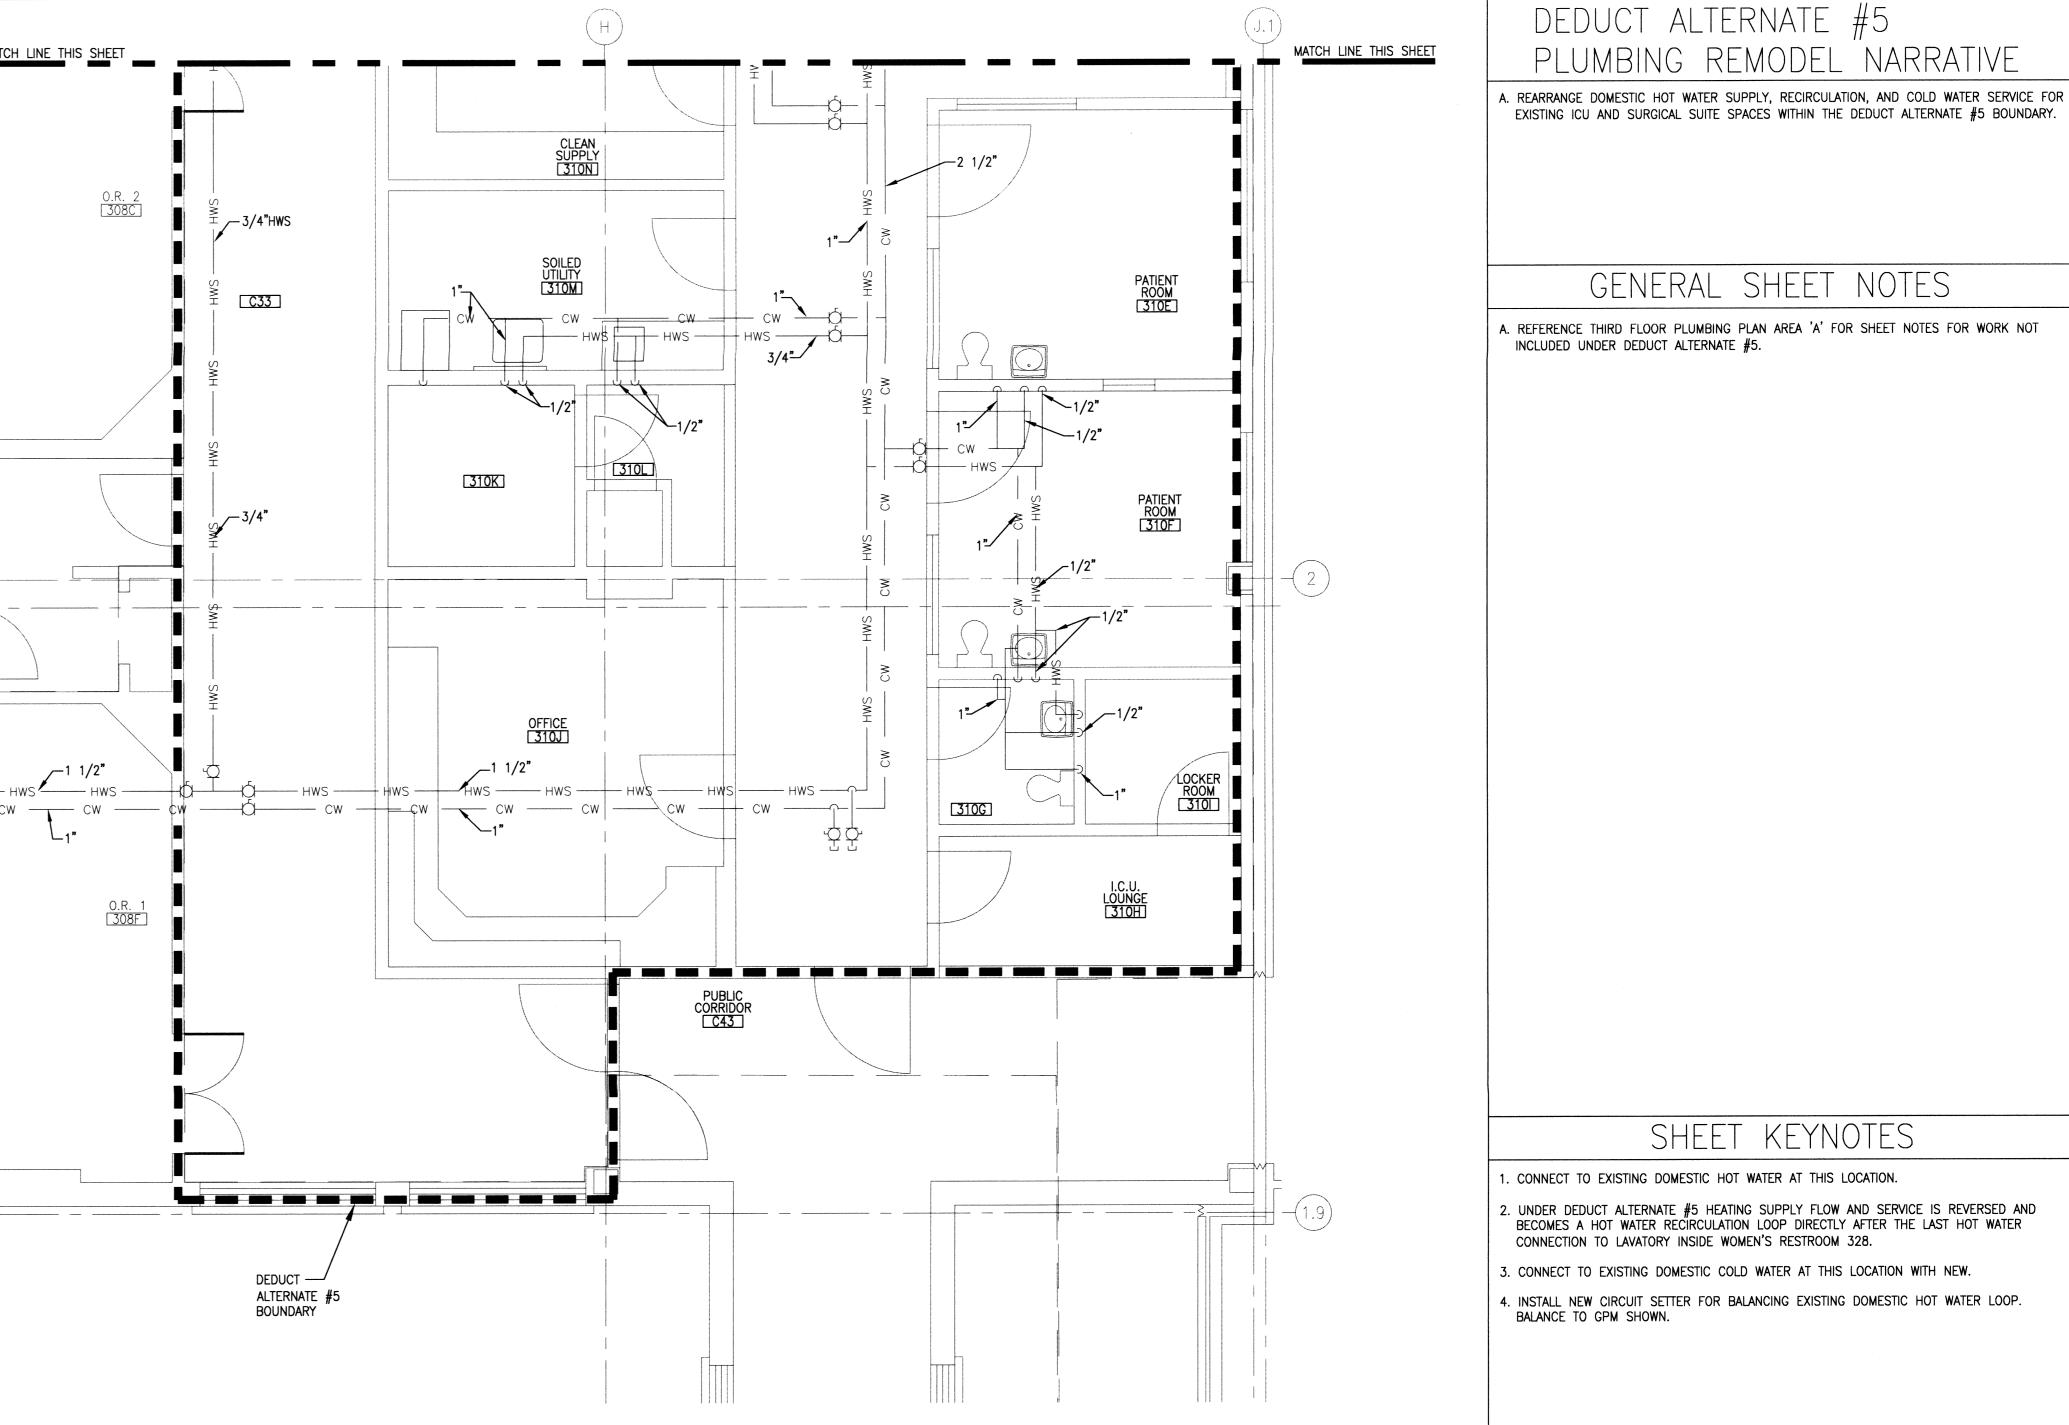


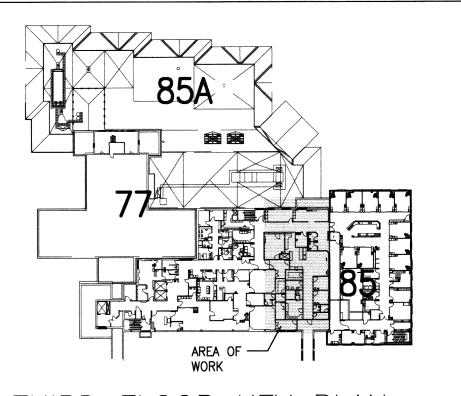
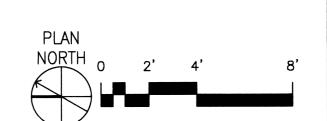
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DATE

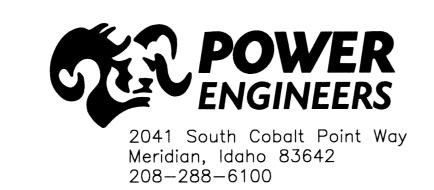

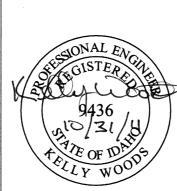

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565 W. Myrtle Street, Suite 225 Boise, Idaho 83702-7606

CAD FILE NAME: 531-317_P101B XREF FILE NAME: 85A3FL_ALT 85M3WA_ALT 531-317_xVAbord


DEDUCT ALTERNATE #5 THIRD FLOOR PLUMBING REMODEL PLAN APPROVED: CHIEF OF FACILITY MANAGEMENT SERVICE

REPLACE AND MODERNIZE SURGERY / INTENSIVE CARE UNIT BUILDING NUMBER CHECKED

531-317 DRAWING NO.

DWG 147 OF 188

DEPARTMENT OF VETERANS AFFAIRS

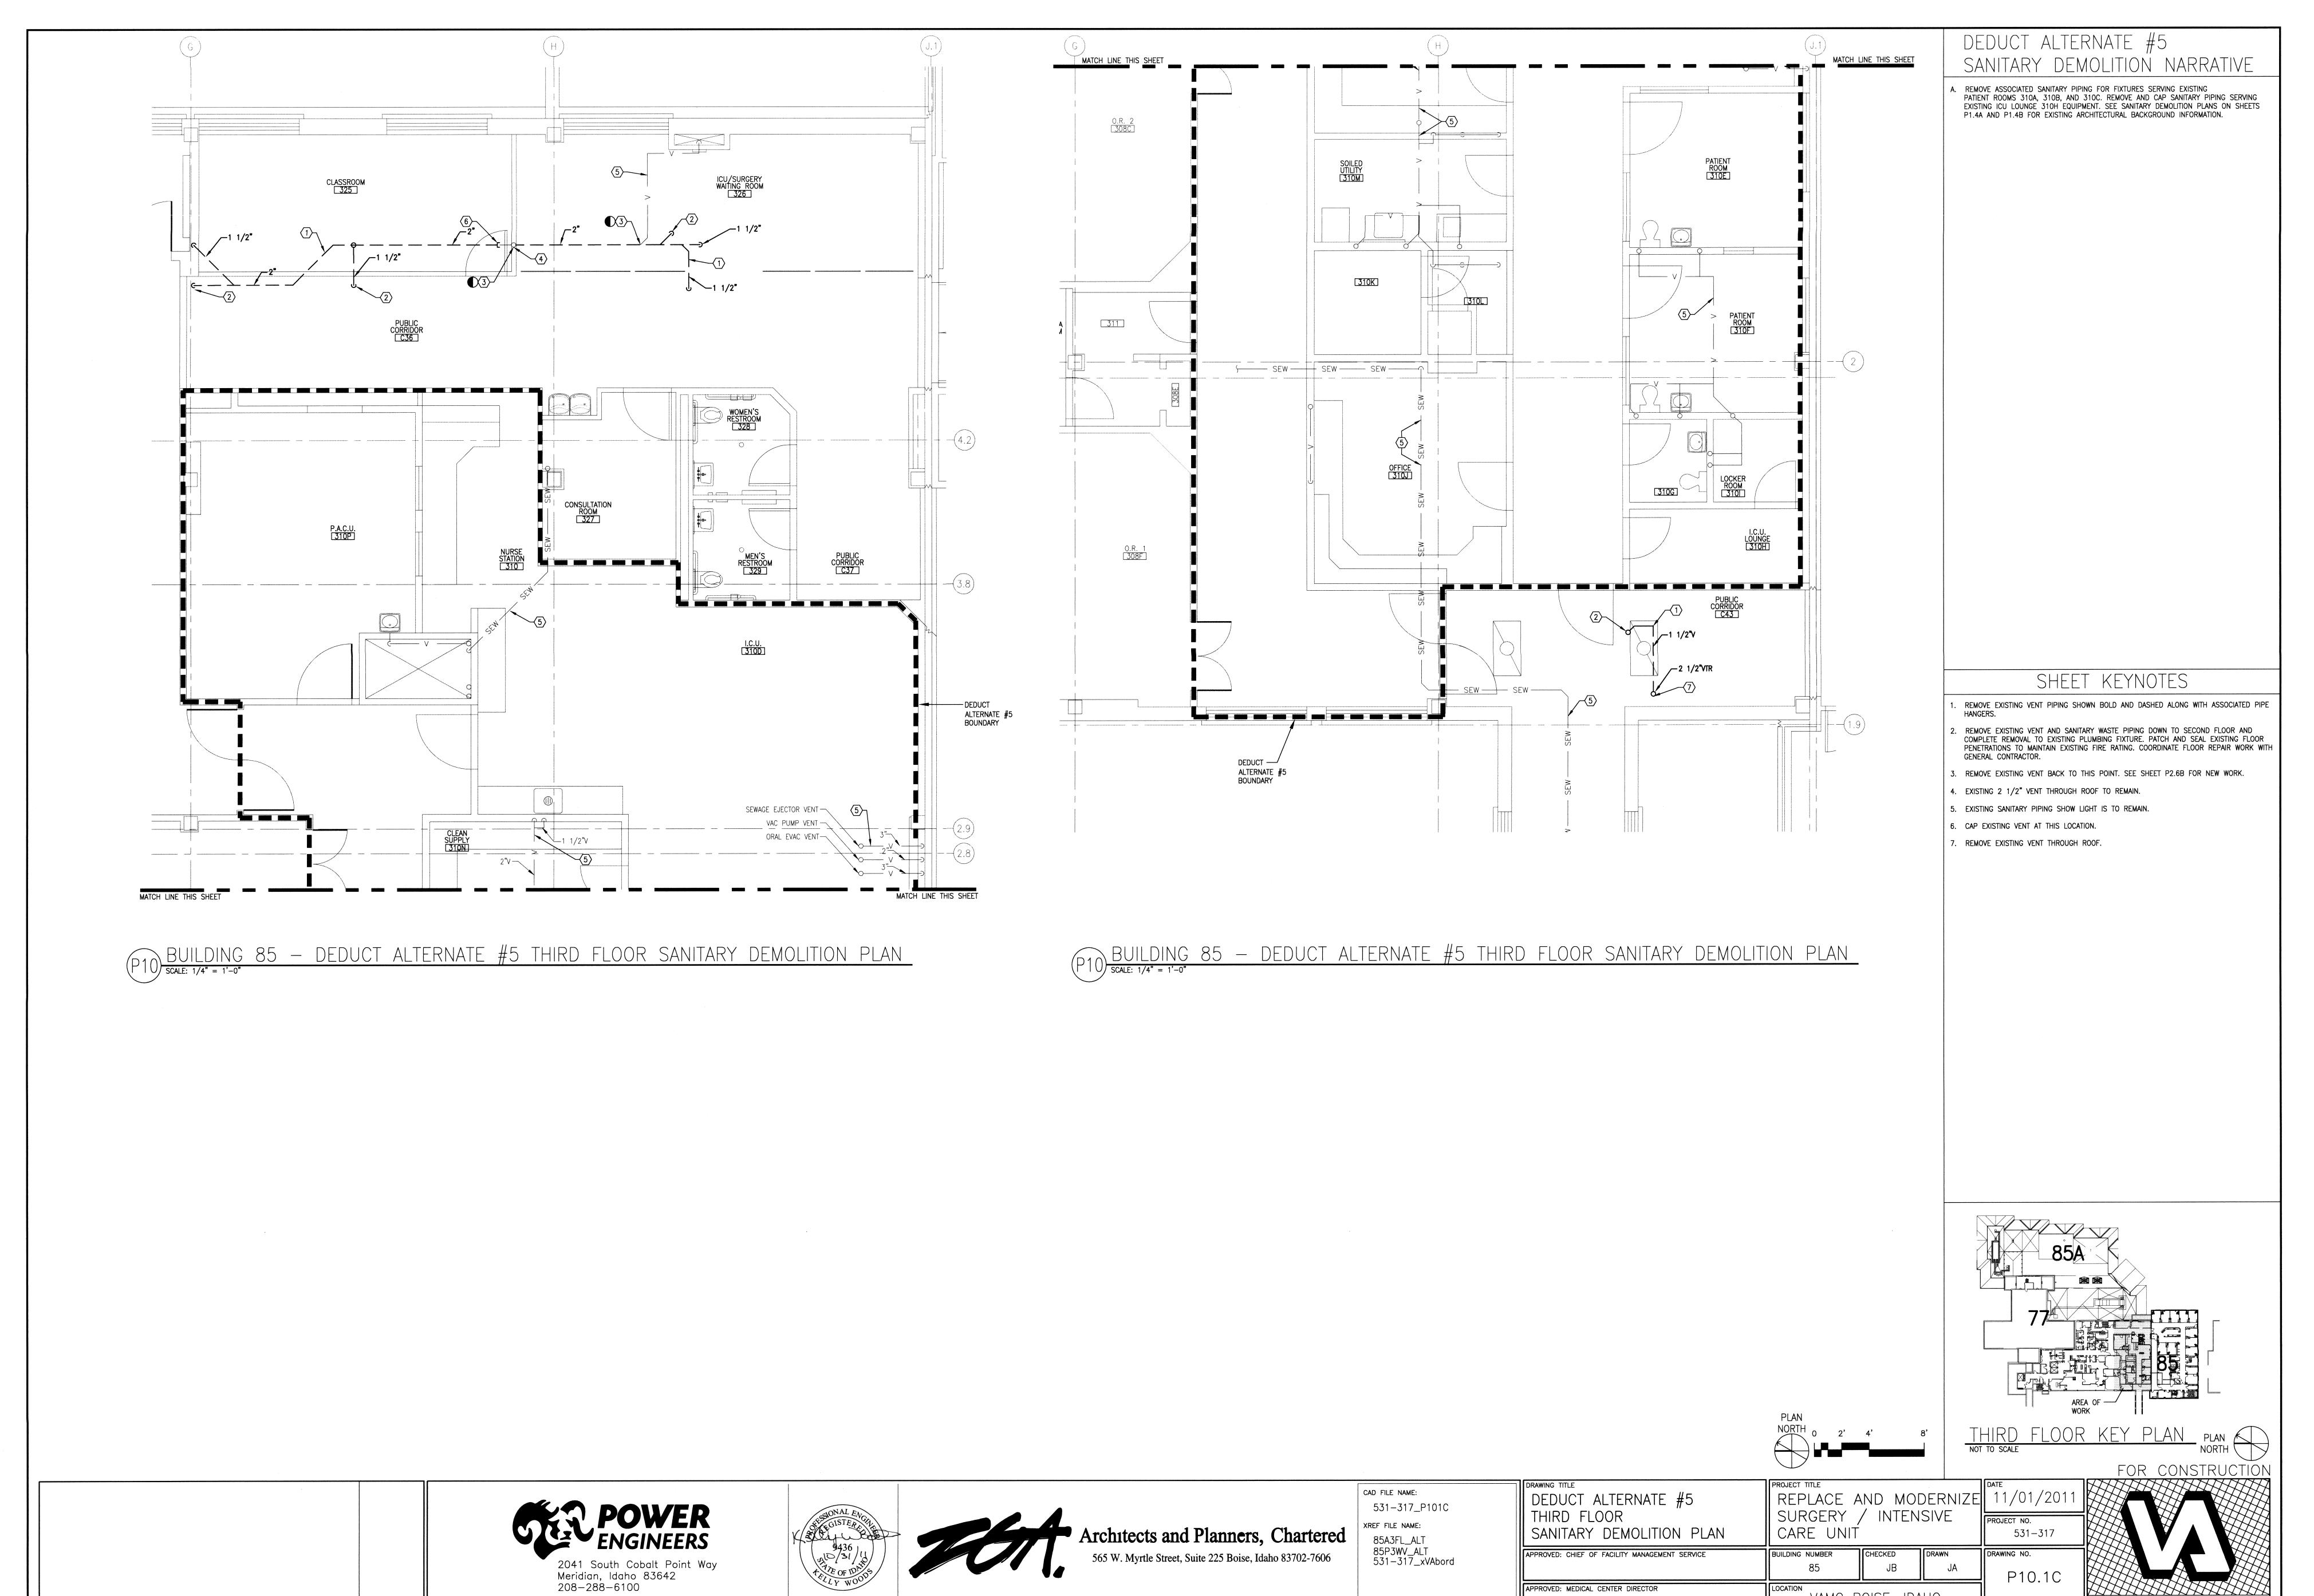



P10.1C

DEPARTMENT OF VETERANS AFFAIRS

VAMC BOISE, IDAHO

APPROVED: MEDICAL CENTER DIRECTOR

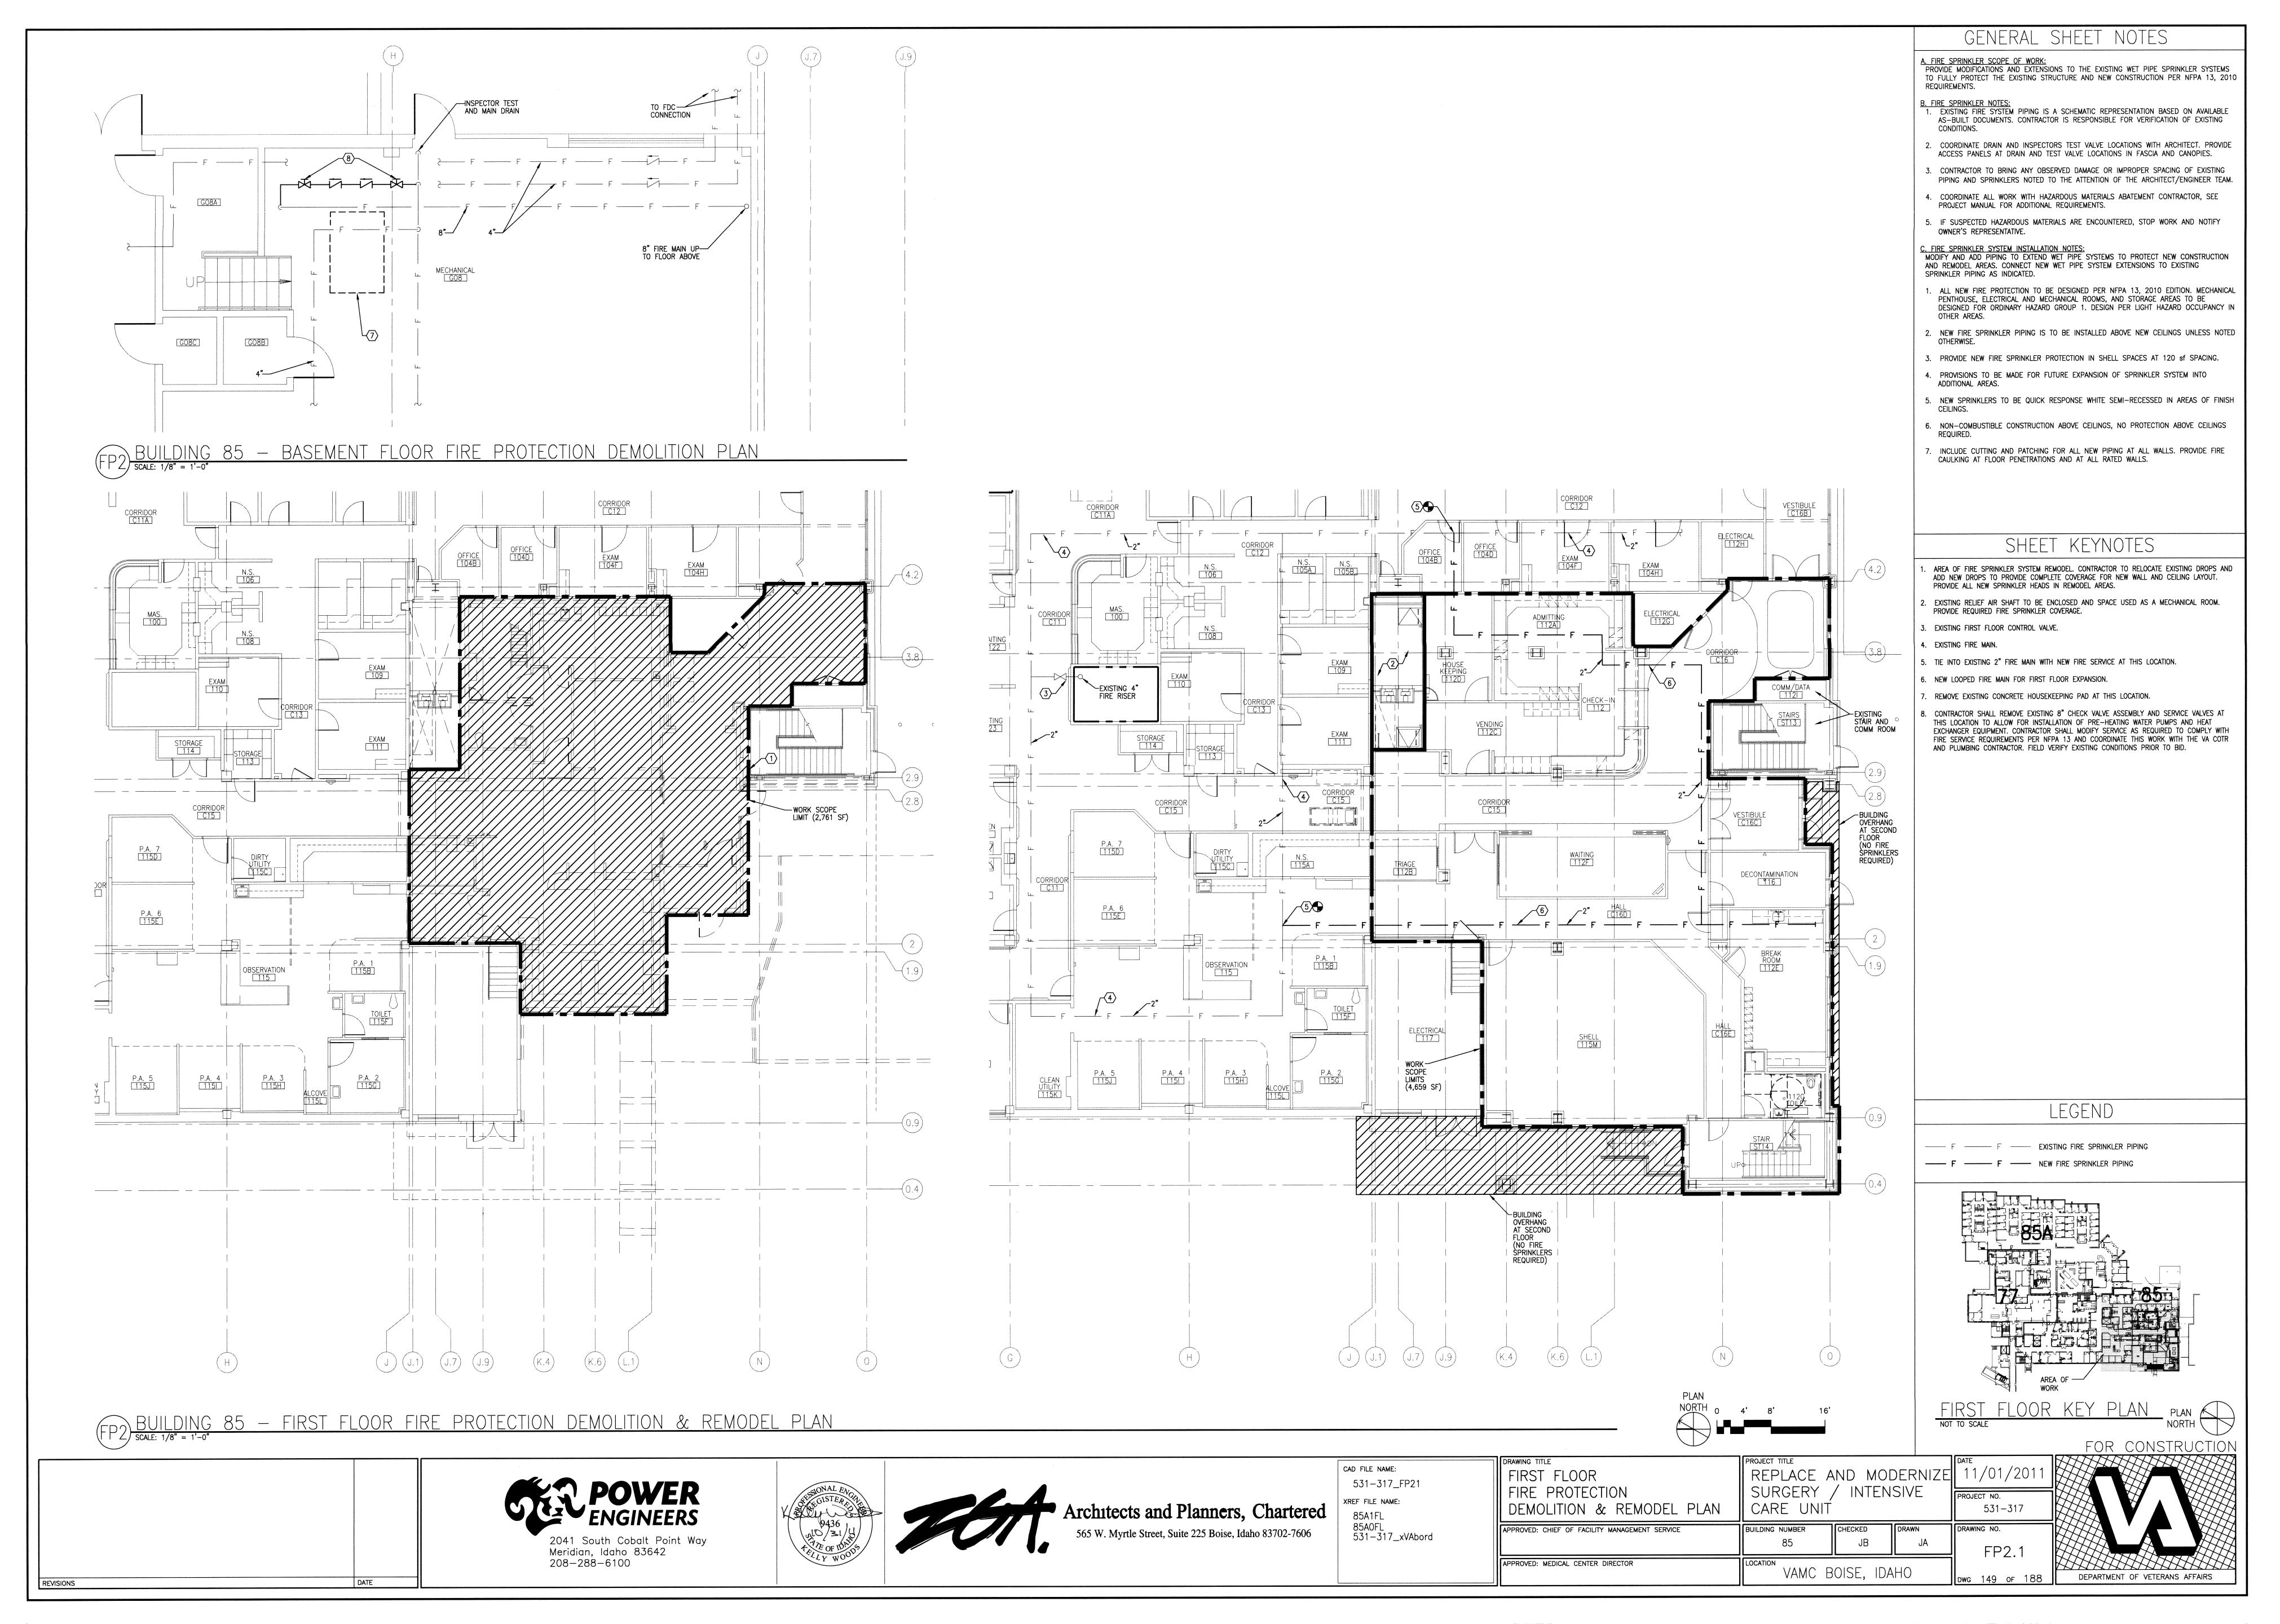

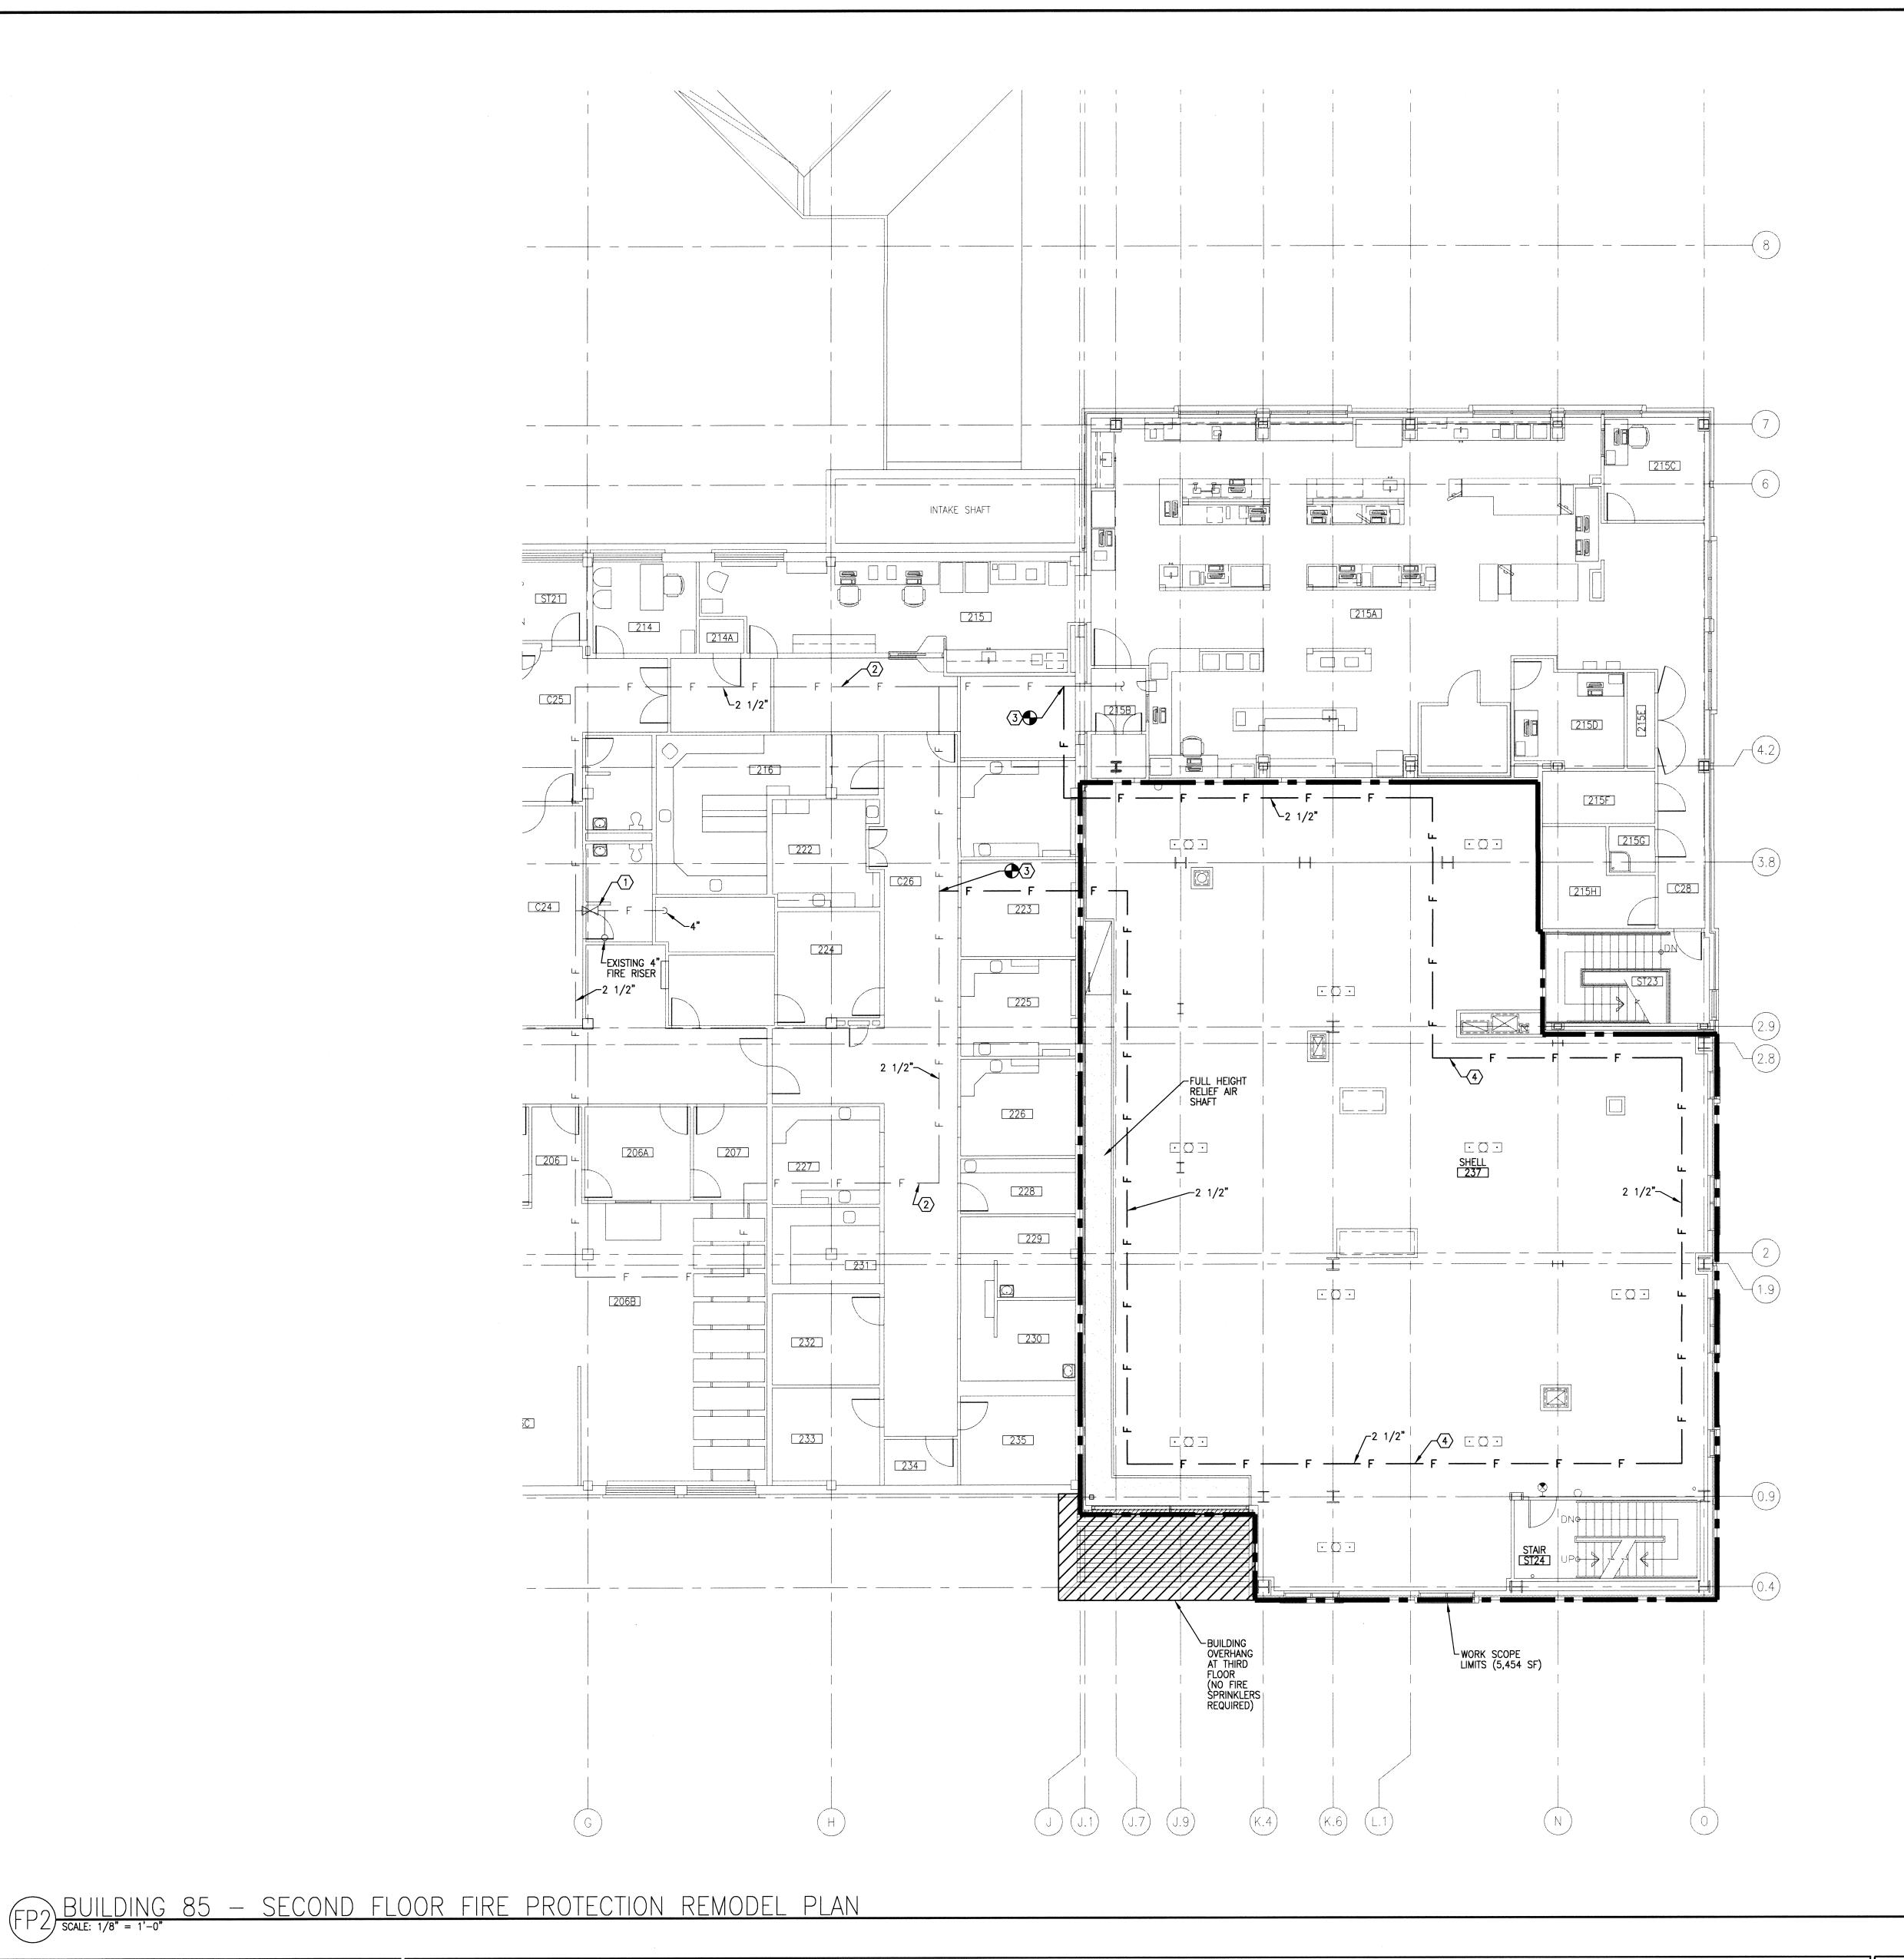

A. FIRE SPRINKLER SCOPE OF WORK:
PROVIDE MODIFICATIONS AND EXTENSIONS TO THE EXISTING WET PIPE SPRINKLER SYSTEMS TO FULLY PROTECT THE EXISTING STRUCTURE AND NEW CONSTRUCTION PER NFPA 13, 2010

- B. FIRE SPRINKLER NOTES:

 1. EXISTING FIRE SYSTEM PIPING IS A SCHEMATIC REPRESENTATION BASED ON AVAILABLE AS-BUILT DOCUMENTS. CONTRACTOR IS RESPONSIBLE FOR VERIFICATION OF EXISTING
- CONDITIONS. . COORDINATE DRAIN AND INSPECTORS TEST VALVE LOCATIONS WITH ARCHITECT. PROVIDE
- ACCESS PANELS AT DRAIN AND TEST VALVE LOCATIONS IN FASCIA AND CANOPIES. 3. CONTRACTOR TO BRING ANY OBSERVED DAMAGE OR IMPROPER SPACING OF EXISTING
- PIPING AND SPRINKLERS NOTED TO THE ATTENTION OF THE ARCHITECT/ENGINEER TEAM. 4. COORDINATE ALL WORK WITH HAZARDOUS MATERIALS ABATEMENT CONTRACTOR, SEE PROJECT MANUAL FOR ADDITIONAL REQUIREMENTS.
- 5. IF SUSPECTED HAZARDOUS MATERIALS ARE ENCOUNTERED, STOP WORK AND NOTIFY OWNER'S REPRESENTATIVE.
- C. FIRE SPRINKLER SYSTEM INSTALLATION NOTES:
 MODIFY AND ADD PIPING TO EXTEND WET PIPE SYSTEMS TO PROTECT NEW CONSTRUCTION AND REMODEL AREAS. CONNECT NEW WET PIPE SYSTEM EXTENSIONS TO EXISTING SPRINKLER PIPING AS INDICATED.
- . ALL NEW FIRE PROTECTION TO BE DESIGNED PER NFPA 13, 2010 EDITION. MECHANICAL PENTHOUSE, ELECTRICAL AND MECHANICAL ROOMS, AND STORAGE AREAS TO BE DESIGNED FOR ORDINARY HAZARD GROUP 1. DESIGN PER LIGHT HAZARD OCCUPANCY IN OTHER AREAS.
- NEW FIRE SPRINKLER PIPING IS TO BE INSTALLED ABOVE NEW CEILINGS UNLESS NOTED OTHERWISE.
- 3. PROVIDE NEW FIRE SPRINKLER PROTECTION IN SHELL SPACES AT 120 sf SPACING. PROVISIONS TO BE MADE FOR FUTURE EXPANSION OF SPRINKLER SYSTEM INTO ADDITIONAL AREAS.
- . NEW SPRINKLERS TO BE QUICK RESPONSE WHITE SEMI-RECESSED IN AREAS OF FINISH
- S. NON-COMBUSTIBLE CONSTRUCTION ABOVE CEILINGS, NO PROTECTION ABOVE CEILINGS REQUIRED.
- INCLUDE CUTTING AND PATCHING FOR ALL NEW PIPING AT ALL WALLS. PROVIDE FIRE CAULKING AT FLOOR PENETRATIONS AND AT ALL RATED WALLS.


SHEET KEYNOTES

- I. EXISTING SECOND FLOOR CONTROL VALVE.
- 2. EXISTING FIRE MAIN.
- 3. TIE INTO EXISTING 2 1/2" FIRE MAIN WITH NEW FIRE SERVICE AT THIS LOCATION.
- 4. NEW LOOPED FIRE MAIN FOR SECOND FLOOR EXPANSION.

LEGEND

F ---- F EXISTING FIRE SPRINKLER PIPING

F --- F NEW FIRE SPRINKLER PIPING

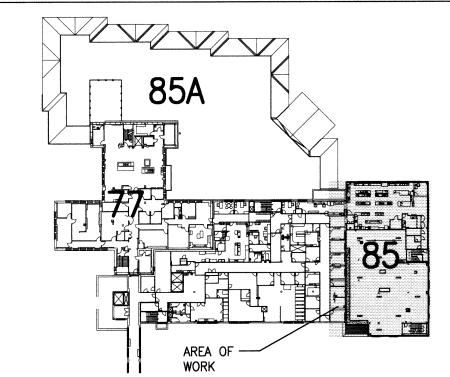

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REVISIONS





531-317_FP22 XREF FILE NAME: 85A2FL 531-317_xVAbord SECOND FLOOR FIRE PROTECTION REMODEL PLAN

PROJECT TITLE
REPLACE AND MODERNIZE 11/01/201

SURGERY / INTENSIVE CARE UNIT

531-317

DRAWING NO.

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APPROVED: CHIEF OF FACILITY MANAGEMENT SERVICE APPROVED: MEDICAL CENTER DIRECTOR

VAMC BOISE, IDAHO

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